



NOTES

- 1 LINE OF SOFFIT.
- 2 CONNECT NEW 16"□ SUPPLY DUCT TO EXISTING 36"x20" SUPPLY DUCT. CONTRACTOR TO VERIFY SIZE AND LOCATION.
- 3 CONNECT NEW 22"x14" R.A. DUCT TO EXISTING MIXING BOX. CONTRACTOR TO VERIFY SIZE AND LOCATION.
- 4 EXISTING 14"x14" NECK LAY-IN R.A.R., 485 CFM.
- 5 24"x20" R.A.R. GRILLE, 1,180 CFM.
- 6 ADJUST CEILING DIFFUSERS TO NEW CEILING HEIGHT
- 7 CONNECT NEW 16" \square S.A. DUCT TO EXISTING 16" \square S.A. DUCT. CONTRACTOR TO VERIFY SIZE AND LOCATION.
- 8 CO2 ROOM SENSOR MOUNTED +48" A.F.F.
- 9 EXISTING 18"x18" R.A. GRILLE TO REMAIN.
- 10 EXISTING 10"x8" S.A. GRILLE AND ASSOCIATED FLEXDUCT TO
- 11 EXISTING CEILING AIR TERMINAL AND ASSOCIATED CONTROLS TO REMAIN.
- 12 EXISTING 9"x9" S.A. DUCT TO REMAIN.
- 13 EXISTING 8"□ FLEXDUCT TO REMAIN.
- EXISTING 24"x12" R.A. DUCT TO REMAIN.

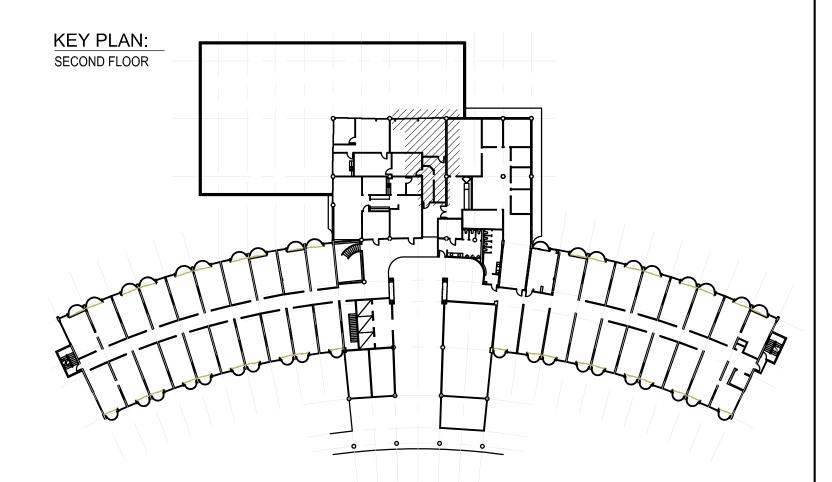

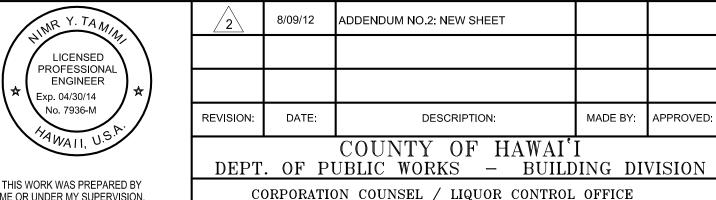

THIS WORK WAS PREPARED BY ME OR UNDER MY SUPERVISION, CONSTRUCTION OF THIS PROJECT WILL BE UNDER MY OBSERVATION.

CORPORATION COUNSEL / LIQUOR CONTROL OFFICE HAZARDOUS MATERIAL MITIGATION AND IMPROVEMENTS PHASE II, RESTORATION JOB NO. B-4087A HILO LAGOON CENTER

Engineering Partners, Inc. Progressive Solutions 455 E.LANIKAULA STREET HILO, HAWAI'I, 96720 PHONE: (808) 933-7900 EMAIL: contact@epihawaii.com


101 Aupuni Street, Unit 230 & Suite 325 T.M.K.: 2-2-014: 010 HILO, HAWAI'I
ADDITIVE ALTERNATE # 3 / NEW AIR CONDITIONING PARTIAL FLOOR PLAN


DESCRIPTION:


MADE BY: APPROVED:


REVIEWED BY:

CHECKED BY: MS DATE: AUG '12 BUILDING DIVISION CHIEF DEPT. OF PUBLIC WORKS COUNTY OF HAWAI'I SHT OF SHTS

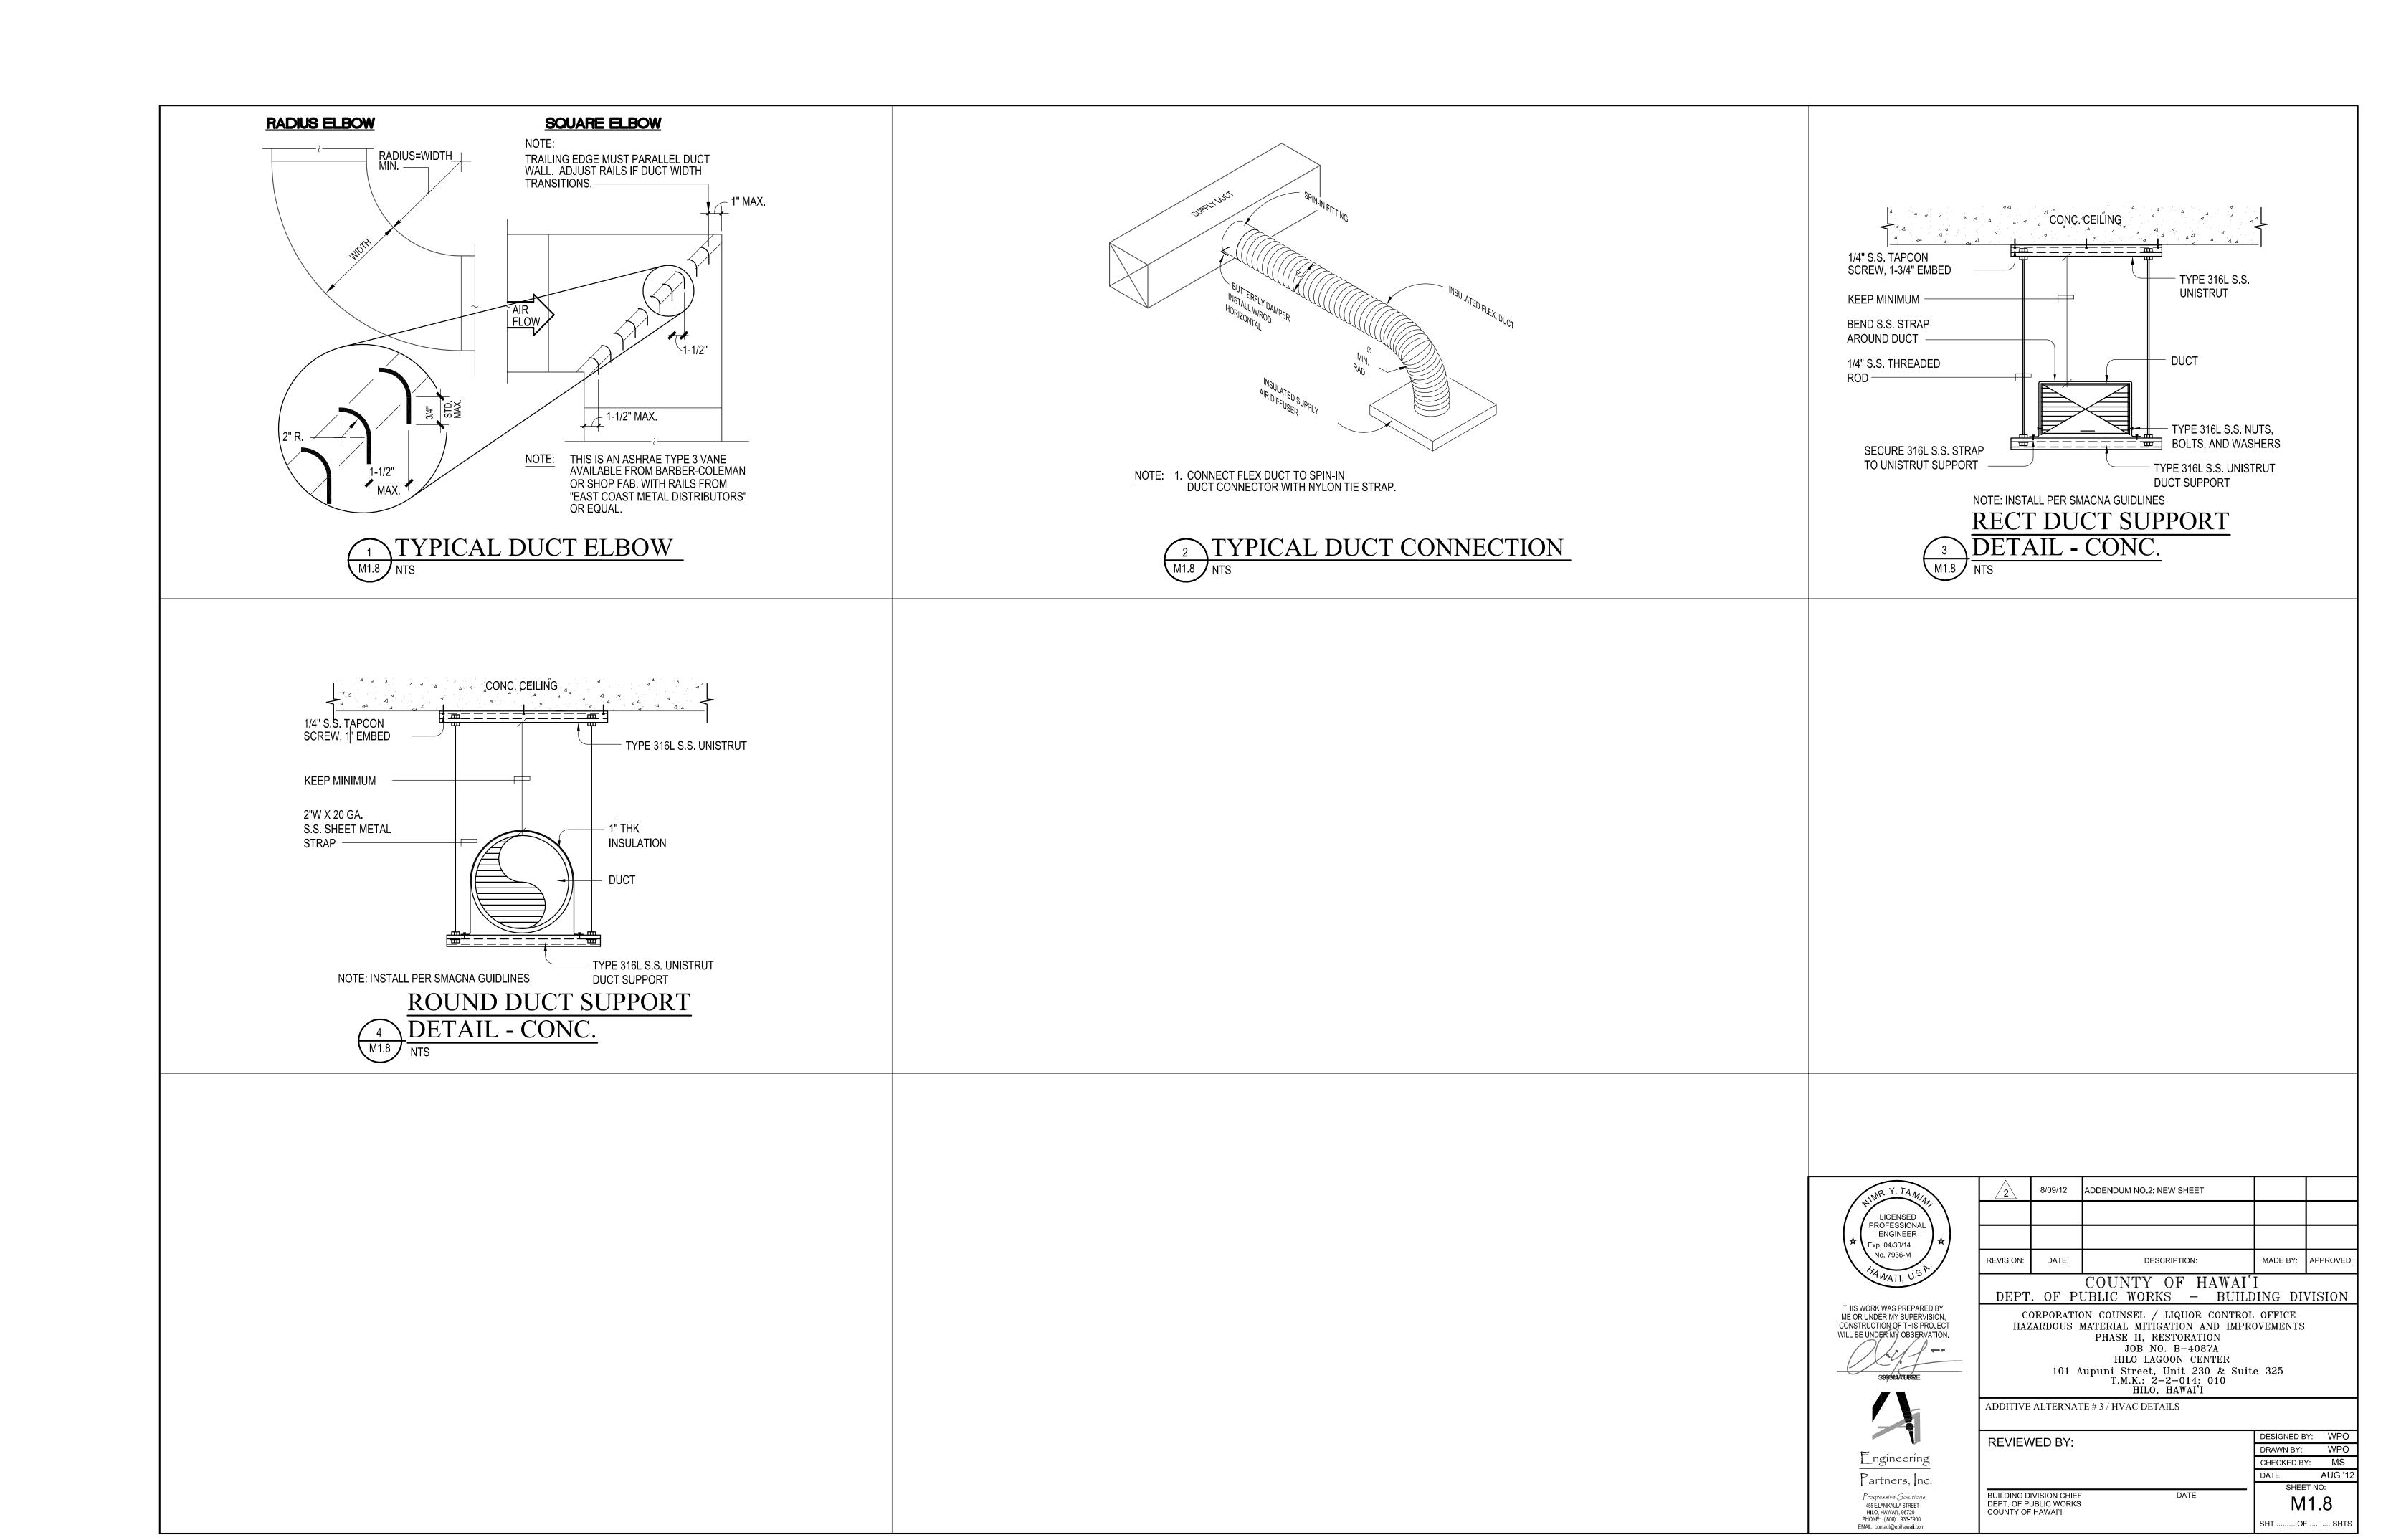

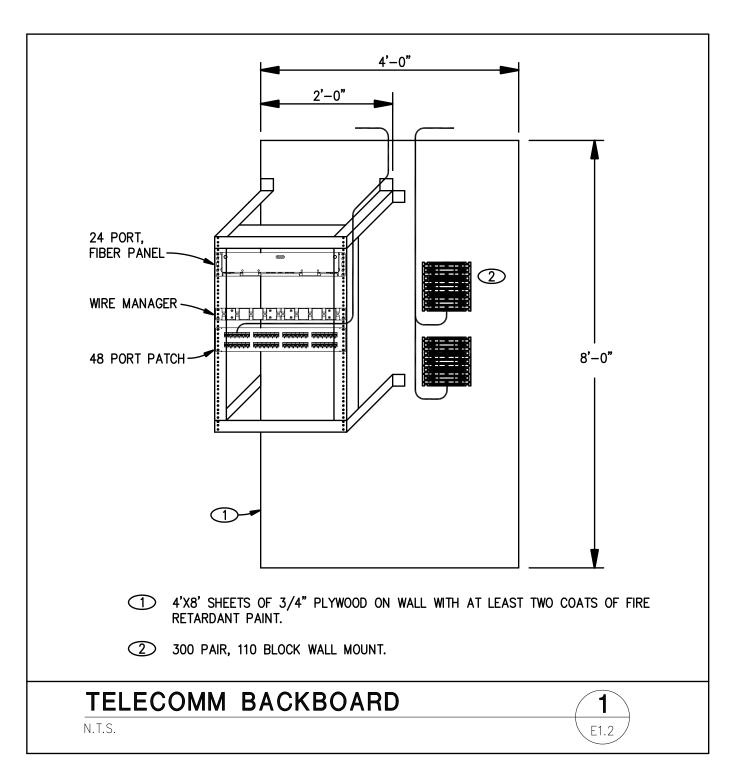


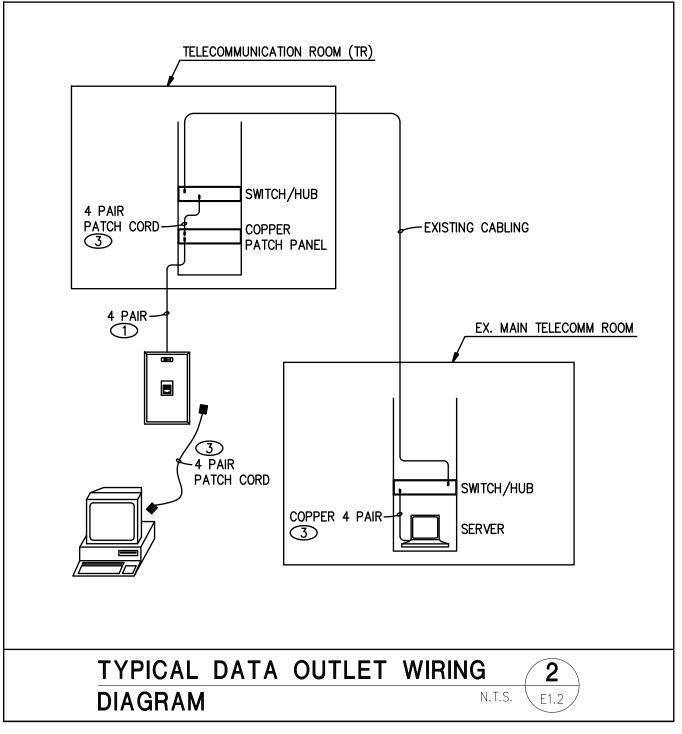


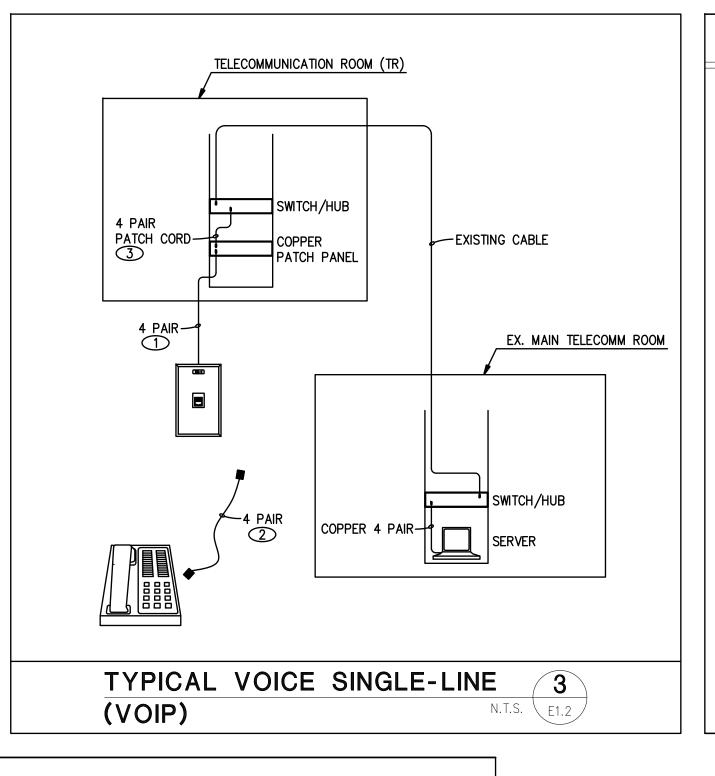



NOTES

- 1 CABLE AND TERMINATION BY CONTRACTOR.
- 2 PROVIDED BY TELEPHONE SYSTEM VENDOR.
- 3 PROVIDED BY OWNER.

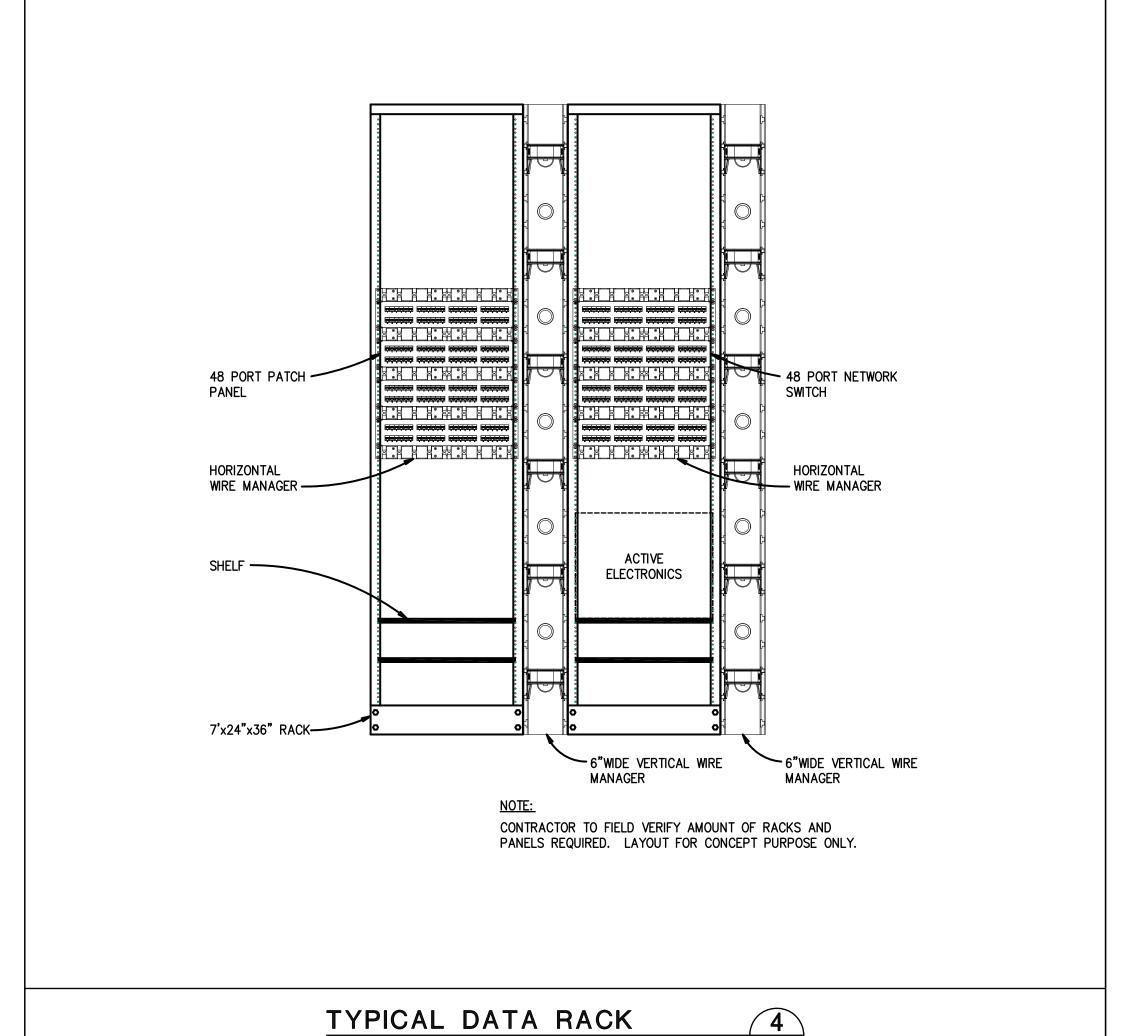

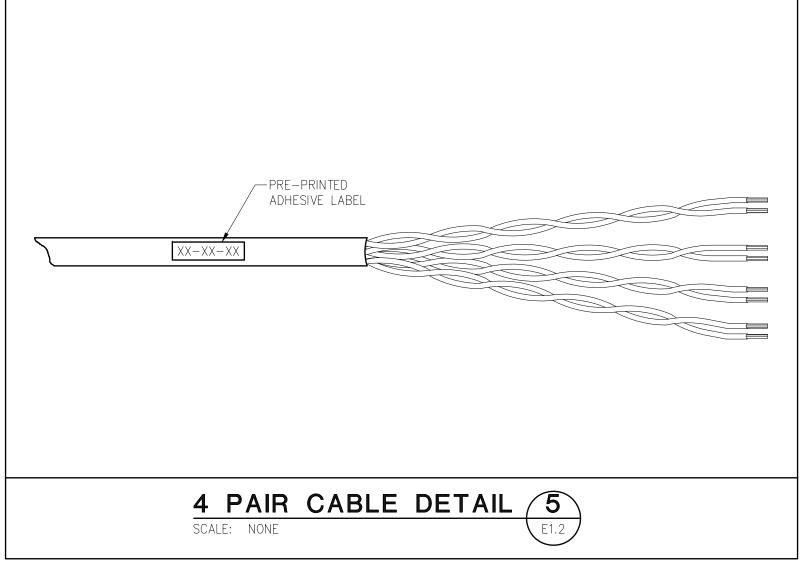

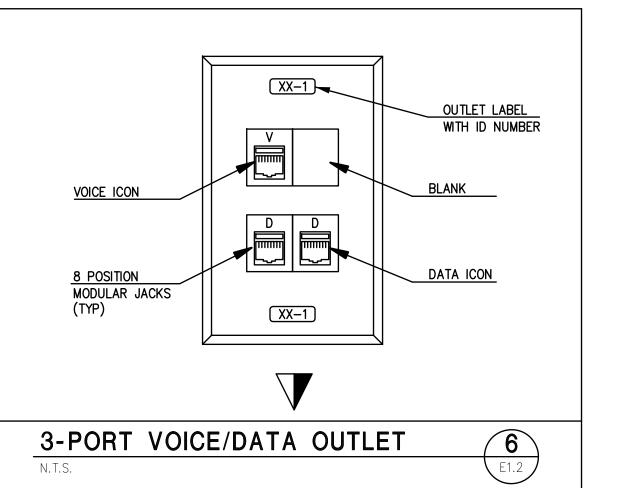

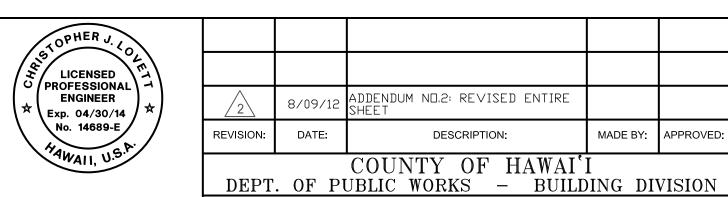

THIS WORK WAS PREPARED BY ME OR UNDER MY SUPERVISION, CONSTRUCTION OF THIS PROJECT

CORPORATION COUNSEL / LIQUOR CONTROL OFFICE HAZARDOUS MATERIAL MITIGATION AND IMPROVEMENTS PHASE II, RESTORATION JOB NO. B-4087A HILO LAGOON CENTER 101 Aupuni Street, Unit 230 & Suite 325 T.M.K.: 2-2-014: 010 HILO, HAWAI'I

	TELECOMMUNICATIONS	DETAILS
V	REVIEWED BY:	

WILL BE UNDER MY OBSERVATION.


SIGNATURE

Engineering

Partners, Inc.

Progressive Solutions
455 ELANIKAULA STREET
HILO, HAWAI'I, 96720
PHONE: (808) 933-7900
EMAIL: contact@epihawaii.com

REVIEWED BY:	DESIGNED BY:	CJL	
NEVIEVVED D1.		DRAWN BY:	CJL
		CHECKED BY:	CJL
		DATE:	MAY '12
		SHEET N	10:
BUILDING DIVISION CHIEF DEPT. OF PUBLIC WORKS COUNTY OF HAWAI`I	DATE	E1.	.2
		SHT OF	SHTS

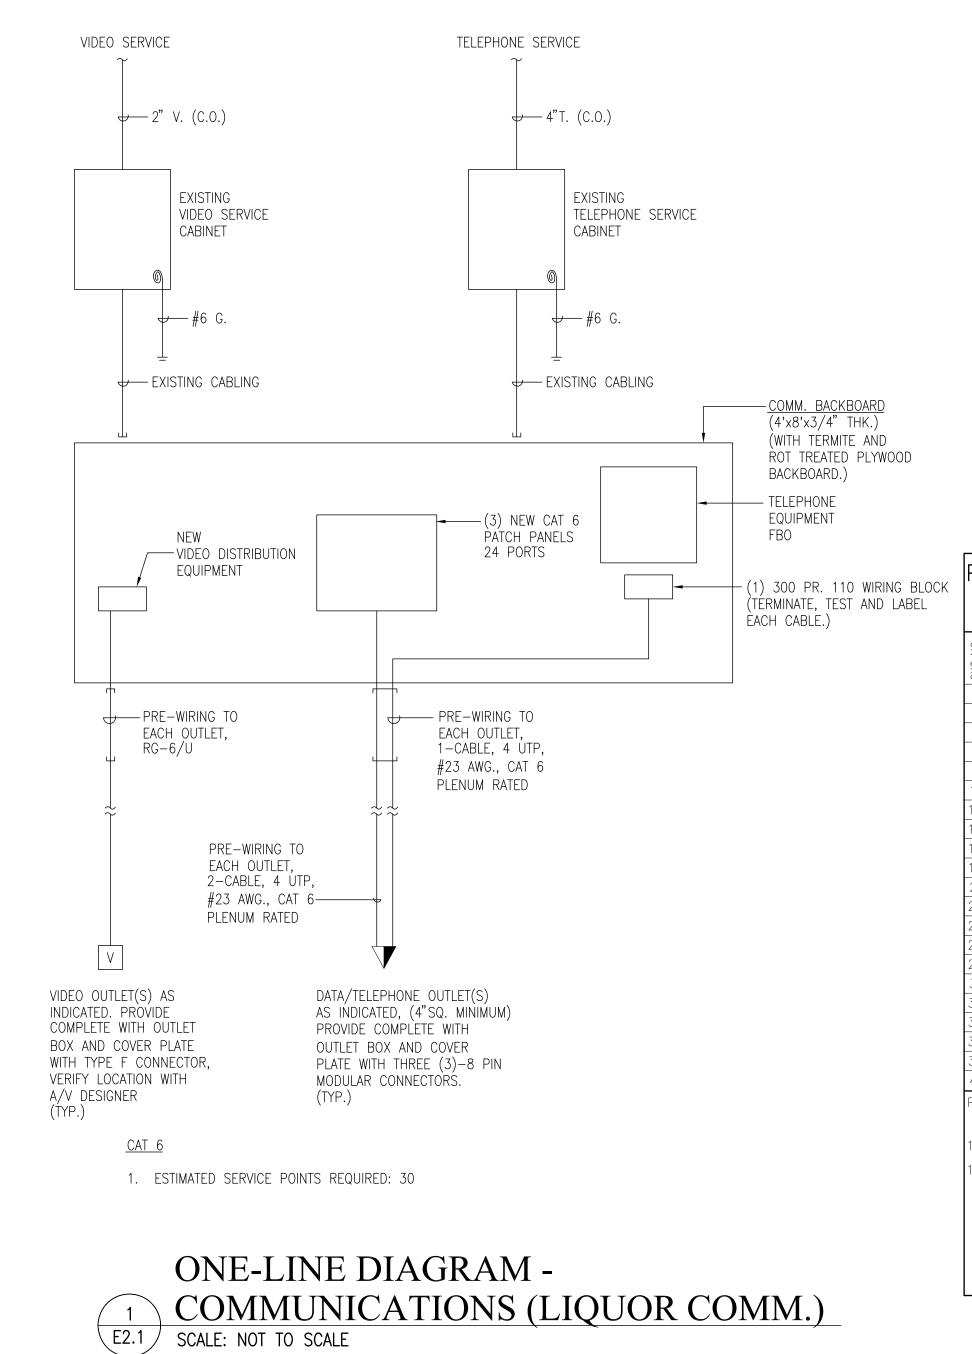

POWER/COMM. BOARD — 120 / 240VAC 75 VA TRANSFORMER (T-1)


<u>NOTES</u>

- 1. DO NOT GROUND THE 24V TRANSFORMER THAT IS TO BE USED WITH THE POWER/COMM. BOARDS. GROUNDING OF THE TRANSFORMER WILL DAMAGE THE POWER/COMM. BOARD AND ALL BOARDS CONNECTED TO IT. NO EXCEPTIONS. DO NOT CONNECT ANY OTHER DEVICES TO THE TRANSFORMER FOR THE POWER/COMM. BOARD.
- 2. TOTAL LENGTH OF ALL MODULAR CABLES USED ON EACH BRANCH (A TO B) CANNOT EXCEED 240 FT.

VAV DAMPER WIRING DETAIL (LIQUOR COMM.) E2.1 SCALE: NOT TO SCALE

DATE 8/3 / 1/2 5 / 18 9/4 DATE 10/4 1	F	PA	NE	EL:		LC		VOLTA			/ 120		3Ø 4	-W		CIRCUIT	CODE:	blar	k (or N: NON-CONTINUOUS L: LONG-CONTINUOUS				
USB (201-11-007 AC TATING: 0,000 MOUNTNS: FLUSH FLOAD DESIGNATION DESCRIPTION C N N C O N N C N N C N N C N N							BUS: 100A																	
																	_ 011101	_			PMFN	IT:	(a l
Comparison Control C					.00.			7110 11711	1110.							\/ Δ							\bigcap	
Toleran Tole			길	교	닏			TT_	Ι.															Ž ⊢
3 R 20 1 RECEPTACLES CONF. TABLE 6 1080	Š	_				MOTE)		L		ØB	ØC	AB	С		ØB	ØC		R	· · ·		PC	_	Š	
5		_	_					 		720		1	•		1260				7			1	-	2
7	-		_					6		-	1080		•			900						1		
9 R 20 1 RECEPTACLES 8 1440 - 240 2 U.C. JIGHTING 20 1 L 10 11 13 13 20 1 RECEPTACLES 8 8 1440 - 900 - SPARE 20 1 1 12 13 13 10 14 15 15 10 10 10 10 10 10			-					1			7	180		•			900					1		-
TI R 20 1 RECEPTACLES 8 8 1440 • • 900 - SPARE 20 1 12 13 12 1 14 15 160 • 900 5 OFFICE RECEPTACLES 20 1 R 14 15 15 20 1 PROJECTOR 1 1 1 160 • 1260 7 OFFICE 7 27 1 R 16 17 70 AHU - 2 1 1 1320 • 1260 7 OFFICE 7 27 1 R 16 17 17 17 18 18 18 18 18	F	_			1		_			1440		1			900				5			1	$\stackrel{R}{\vdash}$	
13		-	_		1		_			-	1440					240			2			1	L	
15	\vdash	_	_					8			٦	1440		•								1	<u> </u>	_
17	\vdash		_					1		180		1	•		900							1		
1320 1320 1720 1215 26 OPEN OFFICE 20 1 1 1 1 1 1 1 1 1	_		_		1			1		-	300					1080			6			1		
21	\vdash	_		20				1			7	1320		•			1260		7	<u>"</u>		1		
23	\vdash	_					_			1320		1	•		720				4			1	$\frac{R}{}$	-
25	\vdash		_/	_	3						1320		•			1215						1	L	
27	-	_	_		1	,		1			٦	60		•			1180	35		'		1	L	_
29 L 20 1 OPEN OFFICE & RECEPT LTS	_			20	/		_	1		70		1	•		1080							1		
31	\vdash	_	_/		2						70		•			900			5			1		_
33	-	_	_		1				22		7	1590		•			1260	\perp	7			1	_	
35 20 1 A/V RECEPTACLES 1 180 • 1440 8 RECEPTACLES 20 1 R 36 37 20 1 TV 4 4 400 • 720 4 OPEN OFFICE 20 1 R 38 39 30 HOT WATER HEATER 1 1500 • 1500 1 HOT WATER HEATER 30 40 41 2 2 42 42 42 44 44 4	-		_			, ,		1		180		1	•		720				4			1	_	
37 20 1 TV	_	_		20		<i>'</i>		1			180		•			360						1		
39 30 HOT WATER HEATER 1 1 1500 • 1500 1 HOT WATER HEATER 30 40 41 2 PANEL NOTES: PHASE TOTALS ØA: 10610 ØB: 12085 ØC: 13810 TOTAL CONNECTED VA 36505 1. REPLACE EXISTING 60A MAIN BREAKER IN PANEL 202 IN EXISTING MECHANICAL ROOM WITH NEW CONNECTED VA (CODE N) 11760 1. REPLACE EXISTING FOR MAIN BREAKER TO PROTECT NEW PANEL 'LC'. CONNECTED VA (CODE R) 20520 CONNECTED VA (CODE K) 0 PANEL CONNECTED KVA 36.5 PANEL DEMAND KVA 32.3 PANEL DEMAND AMPS 89.7			_			,		1			٦	180		•			1440		8			1		
PANEL NOTES: PHASE TOTALS ØA: 10610 ØB: 12085 ØC: 13810 TOTAL CONNECTED VA 36505 CONNECTED VA (CODE N) 11760 1. REPLACE EXISTING 60A MAIN BREAKER IN PANEL 202 IN EXISTING MECHANICAL ROOM WITH NEW CONNECTED VA (CODE L) 4225 CONNECTED VA (CODE K) 0 PANEL CONNECTED KVA 36.5 PANEL DEMAND KVA 32.3 PANEL DEMAND AMPS 89.7	_				1	,		4		400		1	•		720				4	OPEN OFFICE		1	<u>R</u>	-
PANEL NOTES: PHASE TOTALS ØA: 10610 ØB: 12085 ØC: 13810 TOTAL CONNECTED VA 36505 CONNECTED VA (CODE N) 11760 1. REPLACE EXISTING 60A MAIN BREAKER IN PANEL 202 IN EXISTING MECHANICAL ROOM WITH NEW CONNECTED VA (CODE L) 4225 CONNECTED VA (CODE R) 20520 CONNECTED VA (CODE K) 0 PANEL CONNECTED KVA 36.5 PANEL DEMAND KVA 32.3 PANEL DEMAND AMPS 89.7	3	9		30	/	HOT WATER HEATER		1			1500		•			1500			1	HOT WATER HEATER	30		<u> </u>	40
1. REPLACE EXISTING 60A MAIN BREAKER IN PANEL 202 IN EXISTING MECHANICAL ROOM WITH NEW CONNECTED VA (CODE L) 4225 CONNECTED VA (CODE R) 20520 CONNECTED VA (CODE K) 0 PANEL CONNECTED KVA 36.5 PANEL DEMAND KVA 32.3 PANEL DEMAND AMPS 89.7	4	-1		_	2							1500		•			1500					2		42
1. REPLACE EXISTING 60A MAIN BREAKER IN PANEL 202 IN EXISTING MECHANICAL ROOM WITH NEW CONNECTED VA (CODE L) 4225 CONNECTED VA (CODE R) 20520 CONNECTED VA (CODE K) 0 PANEL CONNECTED KVA 36.5 PANEL DEMAND KVA 32.3 PANEL DEMAND AMPS 89.7	P	ANE	EL N	NOTE	ES:		PHA	SE TOT	ALS	ØA:	10610	(2	ß: 12	.085	ō	ØC: 1	3810			TOTAL CONNECTED VA		365	05	
100A/3P BREAKER TO PROTECT NEW PANEL 'LC'. CONNECTED VA (CODE R) CONNECTED VA (CODE K) PANEL CONNECTED KVA 36.5 PANEL DEMAND KVA 32.3 PANEL DEMAND AMPS 89.7												-								CONNECTED VA (CODE N)		1176	60	
100A/3P BREAKER TO PROTECT NEW PANEL 'LC'. CONNECTED VA (CODE R) CONNECTED VA (CODE K) PANEL CONNECTED KVA 36.5 PANEL DEMAND KVA 32.3 PANEL DEMAND AMPS 89.7	1	. RE	EPL/	4CE	EXI	STING 60A MAIN BREAKER IN P	ANEL	202 IN	EXI	ISTING M	ECHANIC.	AL ROOM	Λ WITH	H N	EW					CONNECTED VA (CODE L)		422	 25	
CONNECTED VA (CODE K) 0 PANEL CONNECTED KVA 36.5 PANEL DEMAND KVA 32.3 PANEL DEMAND AMPS 89.7																								
PANEL CONNECTED KVA 36.5 PANEL DEMAND KVA 32.3 PANEL DEMAND AMPS 89.7																			,					
PANEL DEMAND KVA 32.3 PANEL DEMAND AMPS 89.7													-											
PANEL DEMAND AMPS 89.7																								
																								\dashv
																				HIGH Ø AMPS w/ DEMAND				

NEW PANEL "LC"

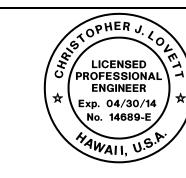

COUNTY OF HAWAI'I
DEPT. OF PUBLIC WORKS - BUILDING DIVISION THIS WORK WAS PREPARED BY ME OR UNDER MY SUPERVISION, CONSTRUCTION OF THIS PROJECT

REVISION:

8/09/12

DATE:

CORPORATION COUNSEL / LIQUOR CONTROL OFFICE HAZARDOUS MATERIAL MITIGATION AND IMPROVEMENTS PHASE II, RESTORATION JOB NO. B-4087A HILO LAGOON CENTER 101 Aupuni Street, Unit 230 & Suite 325 T.M.K.: 2-2-014: 010

ADDENDUM NO.2: REVISED ENTIRE SHEET

DESCRIPTION:

MADE BY: APPROVED:

DESIGNED BY: CJL DRAWN BY: CJL


SIGNATURE

WILL BE UNDER MY OBSERVATION.

Engineering	
Partners, Inc.	
Progressive Solutions 455 E.LANIKAULA STREET HILO, HAWAI'I, 96720 PHONE: (808) 933-7900 EMAIL: contact@epihawaii.com	

		H	ILO,	HAWAI	. 1	
POWER	FLOOR	PLAN	_	NEW	WORK	
REVIEWED BY:						


CHECKED BY: CJL DATE: MAY '12 SHEET NO: BUILDING DIVISION CHIEF DEPT. OF PUBLIC WORKS COUNTY OF HAWAI'I E2.1 SHT OF SHTS

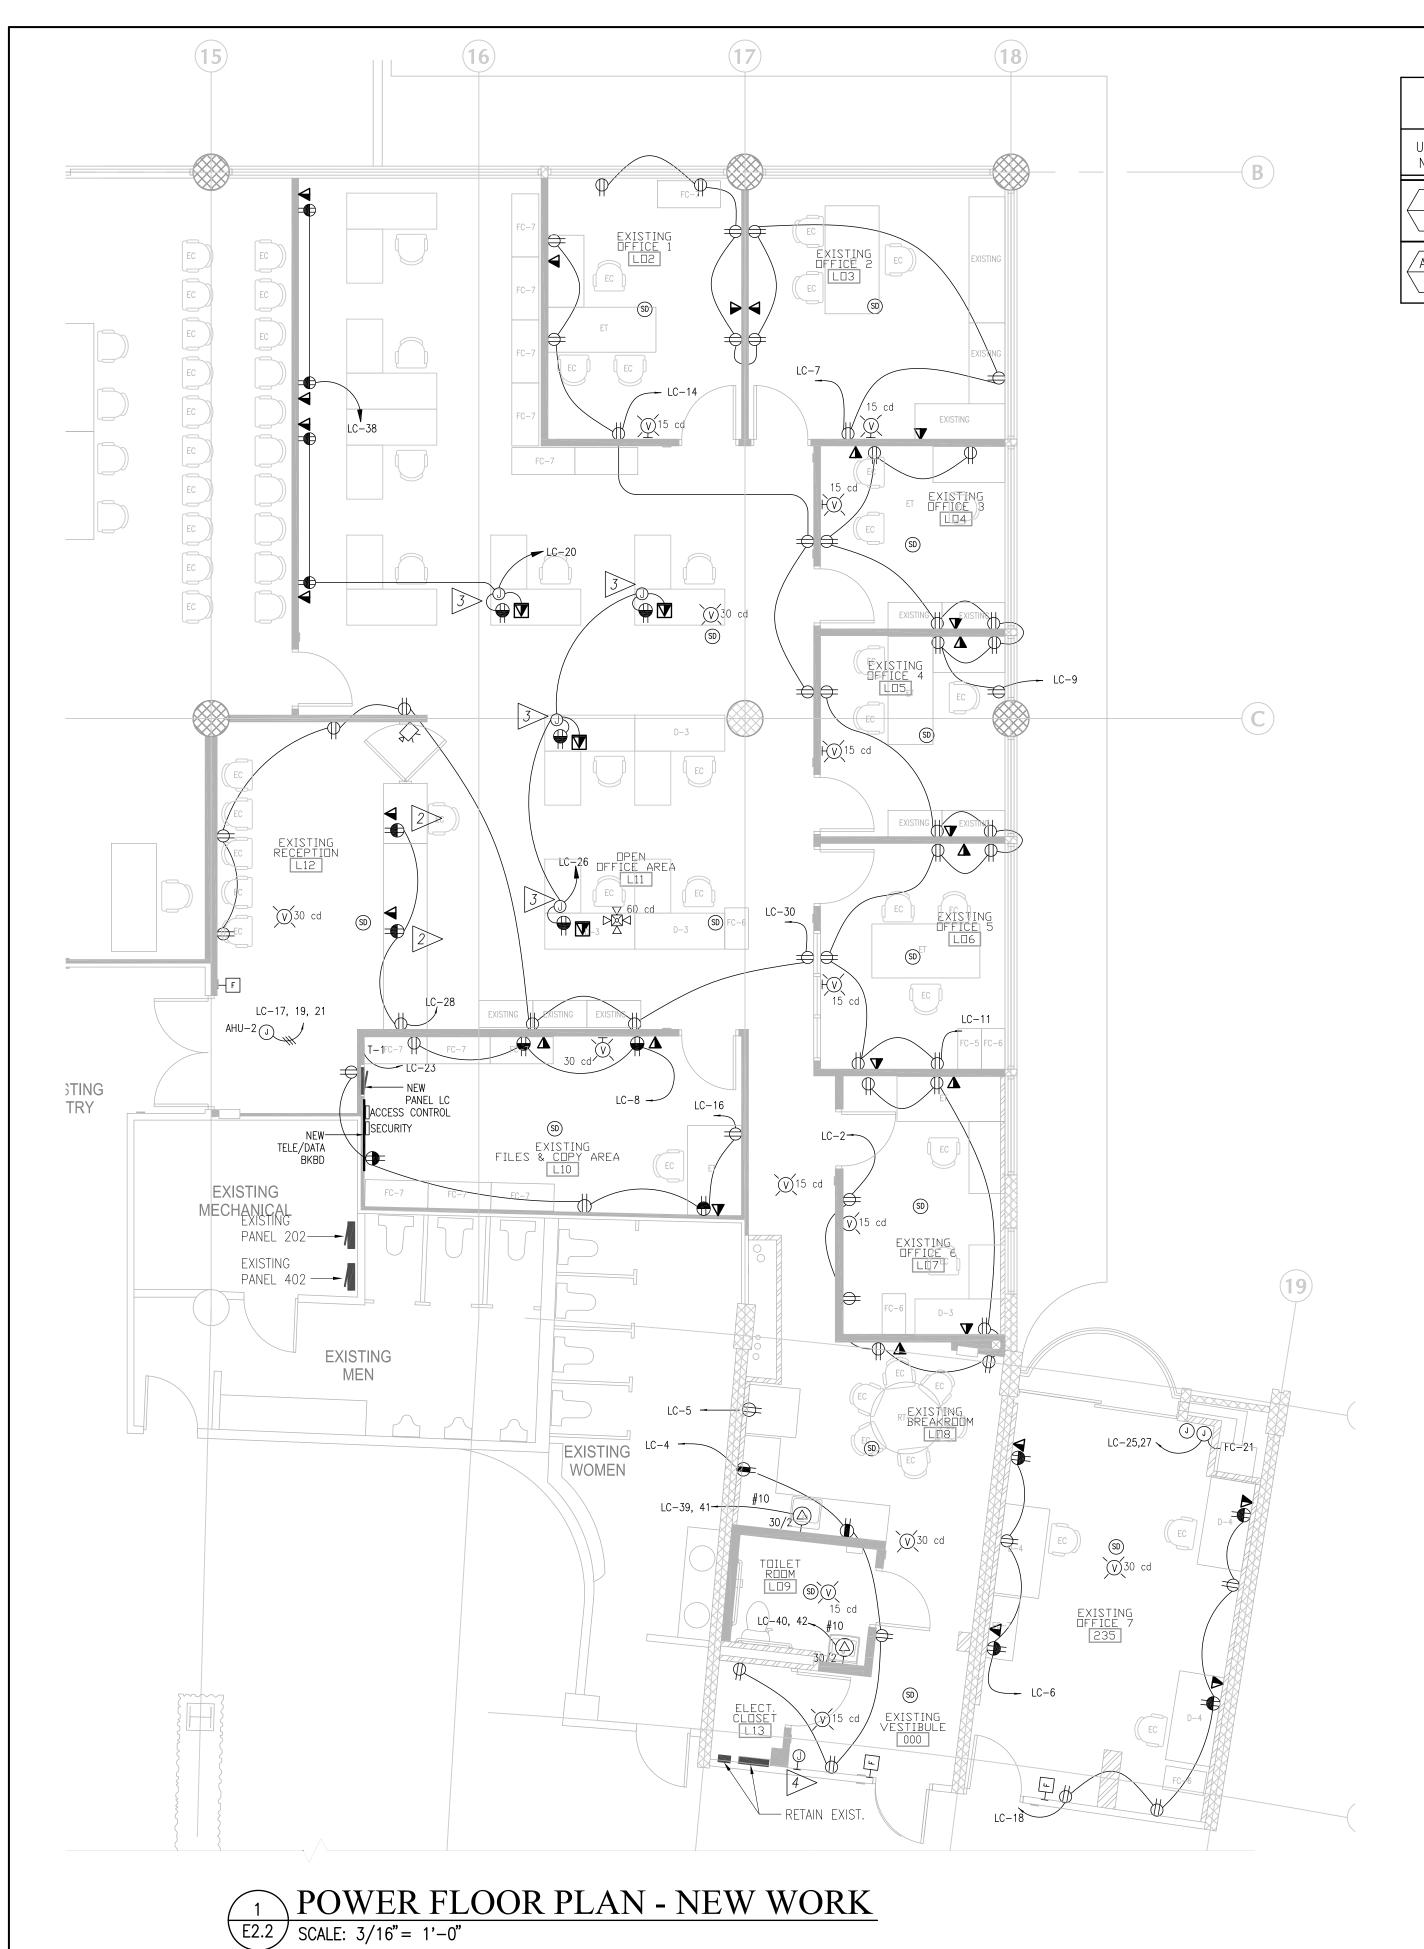

	ELECTRICAL EQUIPMENT SCHEDUE													
UNIT NO.	LOCATION	MOTOR VOLTAGE	APPROX. LENGTH OF RUN	CABLES	МСОР	CONDUIT	DISCONNECT							
FC 21	ROOM 235	208/60/1	AS INDICATED ON DRAWINGS	#12 AWG, Cu, THWN-2 #12 AWG THWN-2 Cu Gnd.	20A/2 HACR RATED	3/4" EMT	IN THE ABSENCE OF PLUG & SOCKET PROVIDED BY THE MANUFACTURER, INSTALL A UL LISTED 600V RATED SWITCH WITHIN 3' FROM THE MOTOR IN A NEMA 1 ENCLOSURE							
AHU 2	LIQUOR COMMISSION	208/60/3	AS INDICATED ON DRAWINGS	3-#12 AWG, Cu THWN-2 1-#12 AWG Gnd.	20A/3 HACR RATED	3/4" EMT	HEAVY DUTY, NEMA-1 ENCLOUSRE "SQUARE D" CAT. #H321N W/ DUAL ELEMENT TIME DELAY FUSE, 17.5 A RATED.							

SHEET NOTES:

- 1 PROVIDE (1) 3/4" C. WITH 6-#12 + 3-#13 GROUND. PROVIDE SEPARATE NEUTRAL AND GROUND CONDUCTORS FOR EACH DEVICE.
- 2> LOCATE RECEPTACLE AND TELE/DATA OUTLET ABOVE AND BELOW COUNTER PER ARCHITECURAL PLANS. ROUTE CONDUIT AND WIRE FOR FOR EACH DEVICE IN CABINETRY.
- 3> PROVIDE WIREMOLD #30TP-2V OR EQUIVALENT POWER POLE FOR CONNECTION TO POWER AND DATA DEVICES AS SHOWN. VERIFY EXACT LOCATION WITH ARCHITECT PRIOR TO ROUGH-IN. PROVIDE CEILING TRIM AND COMPLETE SYSTEM FOR INSTALLATION.
- 4> PROVIDE HOMERUN TO EXISTING SILENT KNIGHT FIRE ALARM SYSTEM IN BASEMENT MAIN ELECTRICAL ROOM APPROXIMATELY 300' FROM PROJECT AREA. VERIFY EXACT DISTANCE AND LOCATION IN FIELD PRIOR TO ROUGH-IN.

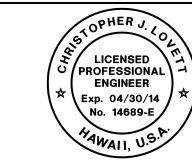

THIS WORK WAS PREPARED BY ME OR UNDER MY SUPERVISION, CONSTRUCTION OF THIS PROJECT

WILL BE UNDER MY OBSERVATION.

SIGNATURE



Engineering Partners, Inc. Progressive Solutions
455 ELANIKAULA STREET
HILO, HAWA'I, 96720
PHONE: (808) 933–7900
EMAIL: contact@epihawaii.com

2	8/09/12	ADDENDUM NO.2: REVISED ENTIRE SHEET		
1	7/20/12	ADDENDUM #1 - DCAB COMMENTS	CJL	
REVISION:	DATE:	DESCRIPTION:	MADE BY:	APPROVED:


COUNTY OF HAWAI'I DEPT. OF PUBLIC WORKS - BUILDING DIVISION

CORPORATION COUNSEL / LIQUOR CONTROL OFFICE HAZARDOUS MATERIAL MITIGATION AND IMPROVEMENTS PHASE II, RESTORATION JOB NO. B-4087A HILO LAGOON CENTER 101 Aupuni Street, Unit 230 & Suite 325 T.M.K.: 2-2-014: 010 HILO, HAWAI'I

POWER PLAN - NEW WORK

DESIGNED BY: CJL
DRAWN BY: CJL REVIEWED BY: CHECKED BY: CJL DATE: MAY '12 SHEET NO: BUILDING DIVISION CHIEF DEPT. OF PUBLIC WORKS COUNTY OF HAWAI'I

SHT OF SHTS

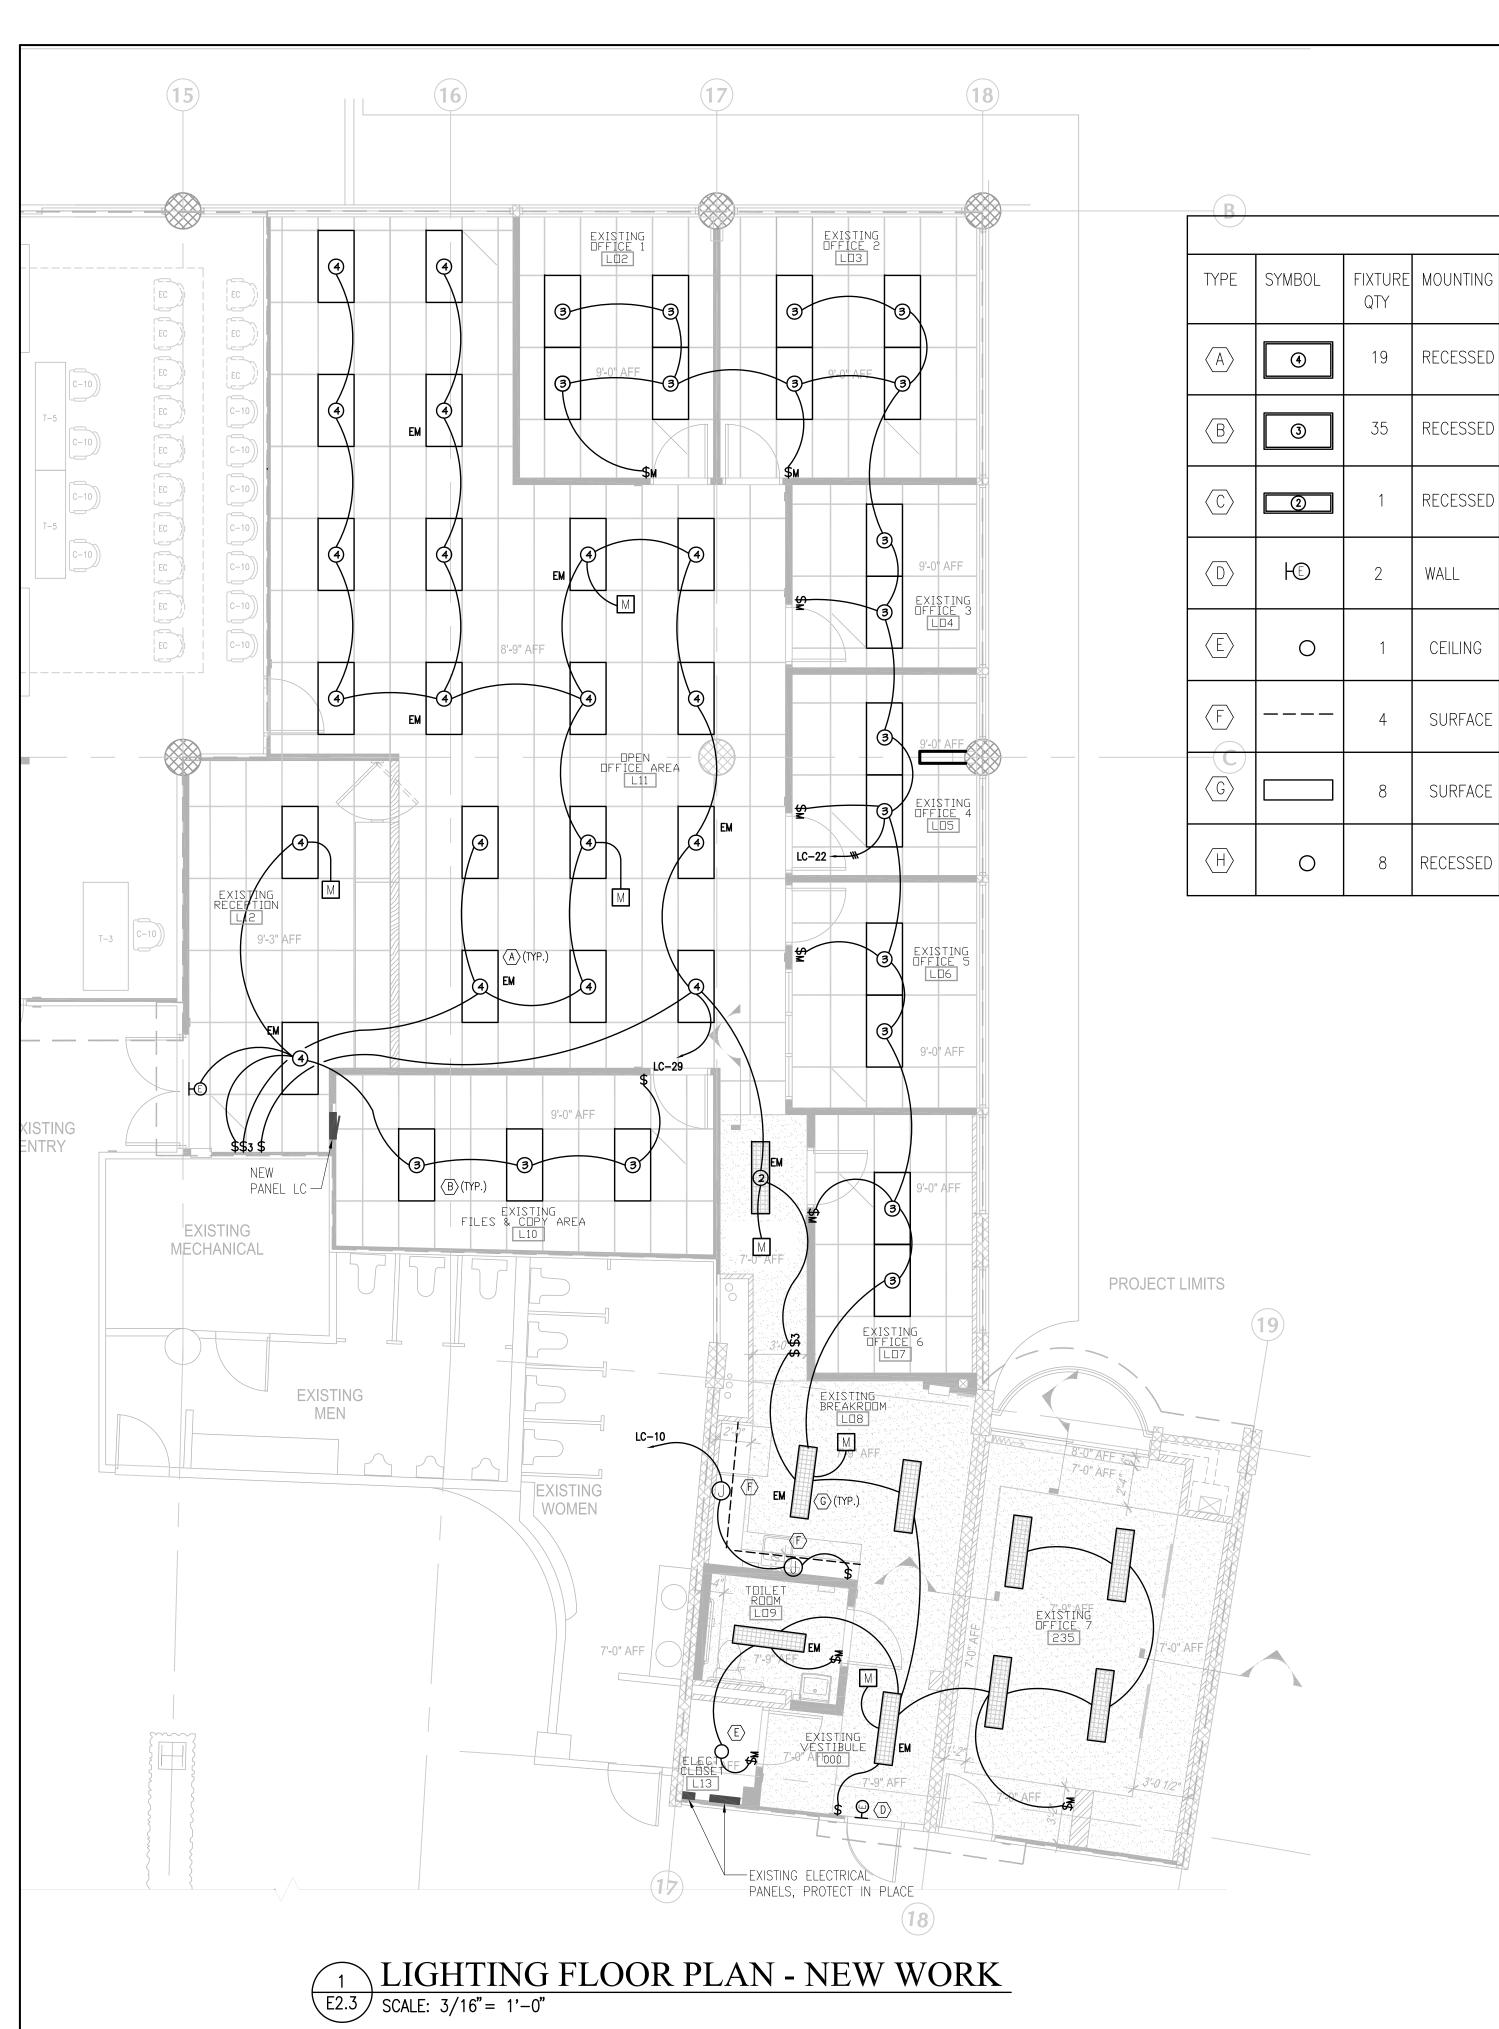

							LUMINAIRE SCHEDULE		
TYPE	SYMBOL	FIXTURE QTY	MOUNTING	LAMP(S)	# OF LAMPS PER FIXTURE	VA	DESCRIPTION	MANUFACTURE	PART #
A	④	19	RECESSED	HUDNUT TL48 3500K	4	75	LOCATE AS INDICATED ON THE DRAWINGS. UL—LISTED, ELECTRONIC BALLAST SOUND RATED A, LUMINAIRE IS SUITABLE FOR DAMP LOCATIONS, THHN WIRE USED THROUGHOUT. REMOVE THE BALLAST BEFORE INSTALLING THE LED LAMPS. FIXTURES WITH 'EM' DESIGNATION PROVIDE EL14 EMERGENCY BATTERY PACK.	HOLOPHANE OR APPROVED EQUAL	HT24-G-4-32-A12125- MVOLT-GEB10IS-(EL14)
B	3	35	RECESSED	HUDNUT TL48 3500K	3	55	LOCATE AS INDICATED ON THE DRAWINGS. UL—LISTED, ELECTRONIC BALLAST SOUND RATED A, LUMINAIRE IS SUITABLE FOR DAMP LOCATIONS, THHN WIRE USED THROUGHOUT. REMOVE THE BALLAST BEFORE INSTALLING THE LED LAMPS. FIXTURES WITH 'EM' DESIGNATION PROVIDE EL14 EMERGENCY BATTERY PACK.	HOLOPHANE OR APPROVED EQUAL	HT24-G-3-32-A12125- MVOLT-GEB10IS-(EL14)
C	2	1	RECESSED	HUDNUT TL48 3500K	2	40	LOCATE AS INDICATED ON THE DRAWINGS. UL-LISTED, ELECTRONIC BALLAST SOUND RATED A, LUMINAIRE IS SUITABLE FOR DAMP LOCATIONS, THHN WIRE USED THROUGHOUT. REMOVE THE BALLAST BEFORE INSTALLING THE LED LAMPS. FIXTURES WITH 'EM' DESIGNATION PROVIDE EL14 EMERGENCY BATTERY PACK.	HOLOPHANE OR APPROVED EQUAL	HT24-E-2-32-A12125- MVOLT-GEB10IS-(EL14)
D	Ю	2	WALL	LED	N/A	5	MAGELLAN EC SERIES LED EXIT, STANDARD SUSTAINED EMERGENCY BATTERY OPERATION FOR 90 MINUTES. DUAL INDICATOR ON FACE OF UNIT SIGNIFYING AC UTILITY PRESENCE AND CHARGE STATUS. ORDERED W/ 13"W X 8"H X 2.5"DP. MAXIMUM MOUNTING HEIGHT	HOLOPHANE OR APPROVED EQUAL	_
E	0	1	CEILING	CFL TWIN TUBE	1	15	9" ROUND, 13 WATT CFL	PRESCOLITE OR APPROVED EQUAL	9424-13
F		4	SURFACE	13W T5	2	30	LOCATE UNDER CABINET. UL-LISTED, INSTANT START ELECTRONIC BALLAST. PROVIDE (4) 3' FIXTURES.	LITHONIA OR APPROVED EQUAL	UCHZE120LPWW
G		8	SURFACE	HUDNUT TL48 3500K	2	40	LOCATE AS INDICATED ON THE DRAWINGS. UL—LISTED, ELECTRONIC BALLAST SOUND RATED A, LUMINAIRE IS SUITABLE FOR DAMP LOCATIONS, THHN WIRE USED THROUGHOUT. REMOVE THE BALLAST BEFORE INSTALLING THE LED LAMPS. FIXTURES WITH 'EM' DESIGNATION PROVIDE EL14 EMERGENCY BATTERY PACK.	LITHONIA OR APPROVED EQUAL	2AW-2-32-MVOLT-GEB10IS
H	0	8	RECESSED	INCL. W/ FIXTURE 3500K	N/A	15	LOCATE AS INDICATED ON THE DRAWINGS. 6" ROUND, DROP CEILING MOUNT, 3500K COLOR WITH MIN. 75 CRI LED DOWNLIGHT FIXTURE WIDE CURVED WHITE TRIM	ENLUX OR APPROVED EQUAL	DL-2-5-12-3-4-0-WF
					<u>.</u>				



ADDENDUM NO.2: REVISED ENTIRE ADDENDUM #1 - DCAB COMMENTS DATE: MADE BY: APPROVED: REVISION: DESCRIPTION:

THIS WORK WAS PREPARED BY ME OR UNDER MY SUPERVISION, CONSTRUCTION OF THIS PROJECT WILL BE UNDER MY OBSERVATION.

COUNTY OF HAWAI'I DEPT. OF PUBLIC WORKS - BUILDING DIVISION CORPORATION COUNSEL / LIQUOR CONTROL OFFICE
HAZARDOUS MATERIAL MITIGATION AND IMPROVEMENTS
PHASE II, RESTORATION

JOB NO. B-4087A

HILO LAGOON CENTER

101 Aupuni Street, Unit 230 & Suite 325

T.M.K.: 2-2-014: 010

HILO, HAWAI'I

DESIGNED BY: CJL
DRAWN BY: CJL

CHECKED BY: CJL

DATE: MAY '12


SHEET NO:

SHT OF SHTS

LIGHTING FLOOR PLAN NEW WORK


Engineering Partners, Inc. Progressive Solutions
455 ELANIKAULA STREET
HILO, HAWAI'I, 96720
PHONE: (808) 933-7900
EMAIL: contact@epihawaii.com

REVIEWED BY:	
BUILDING DIVISION CHIEF DEPT. OF PUBLIC WORKS COUNTY OF HAWAI'I	DATE

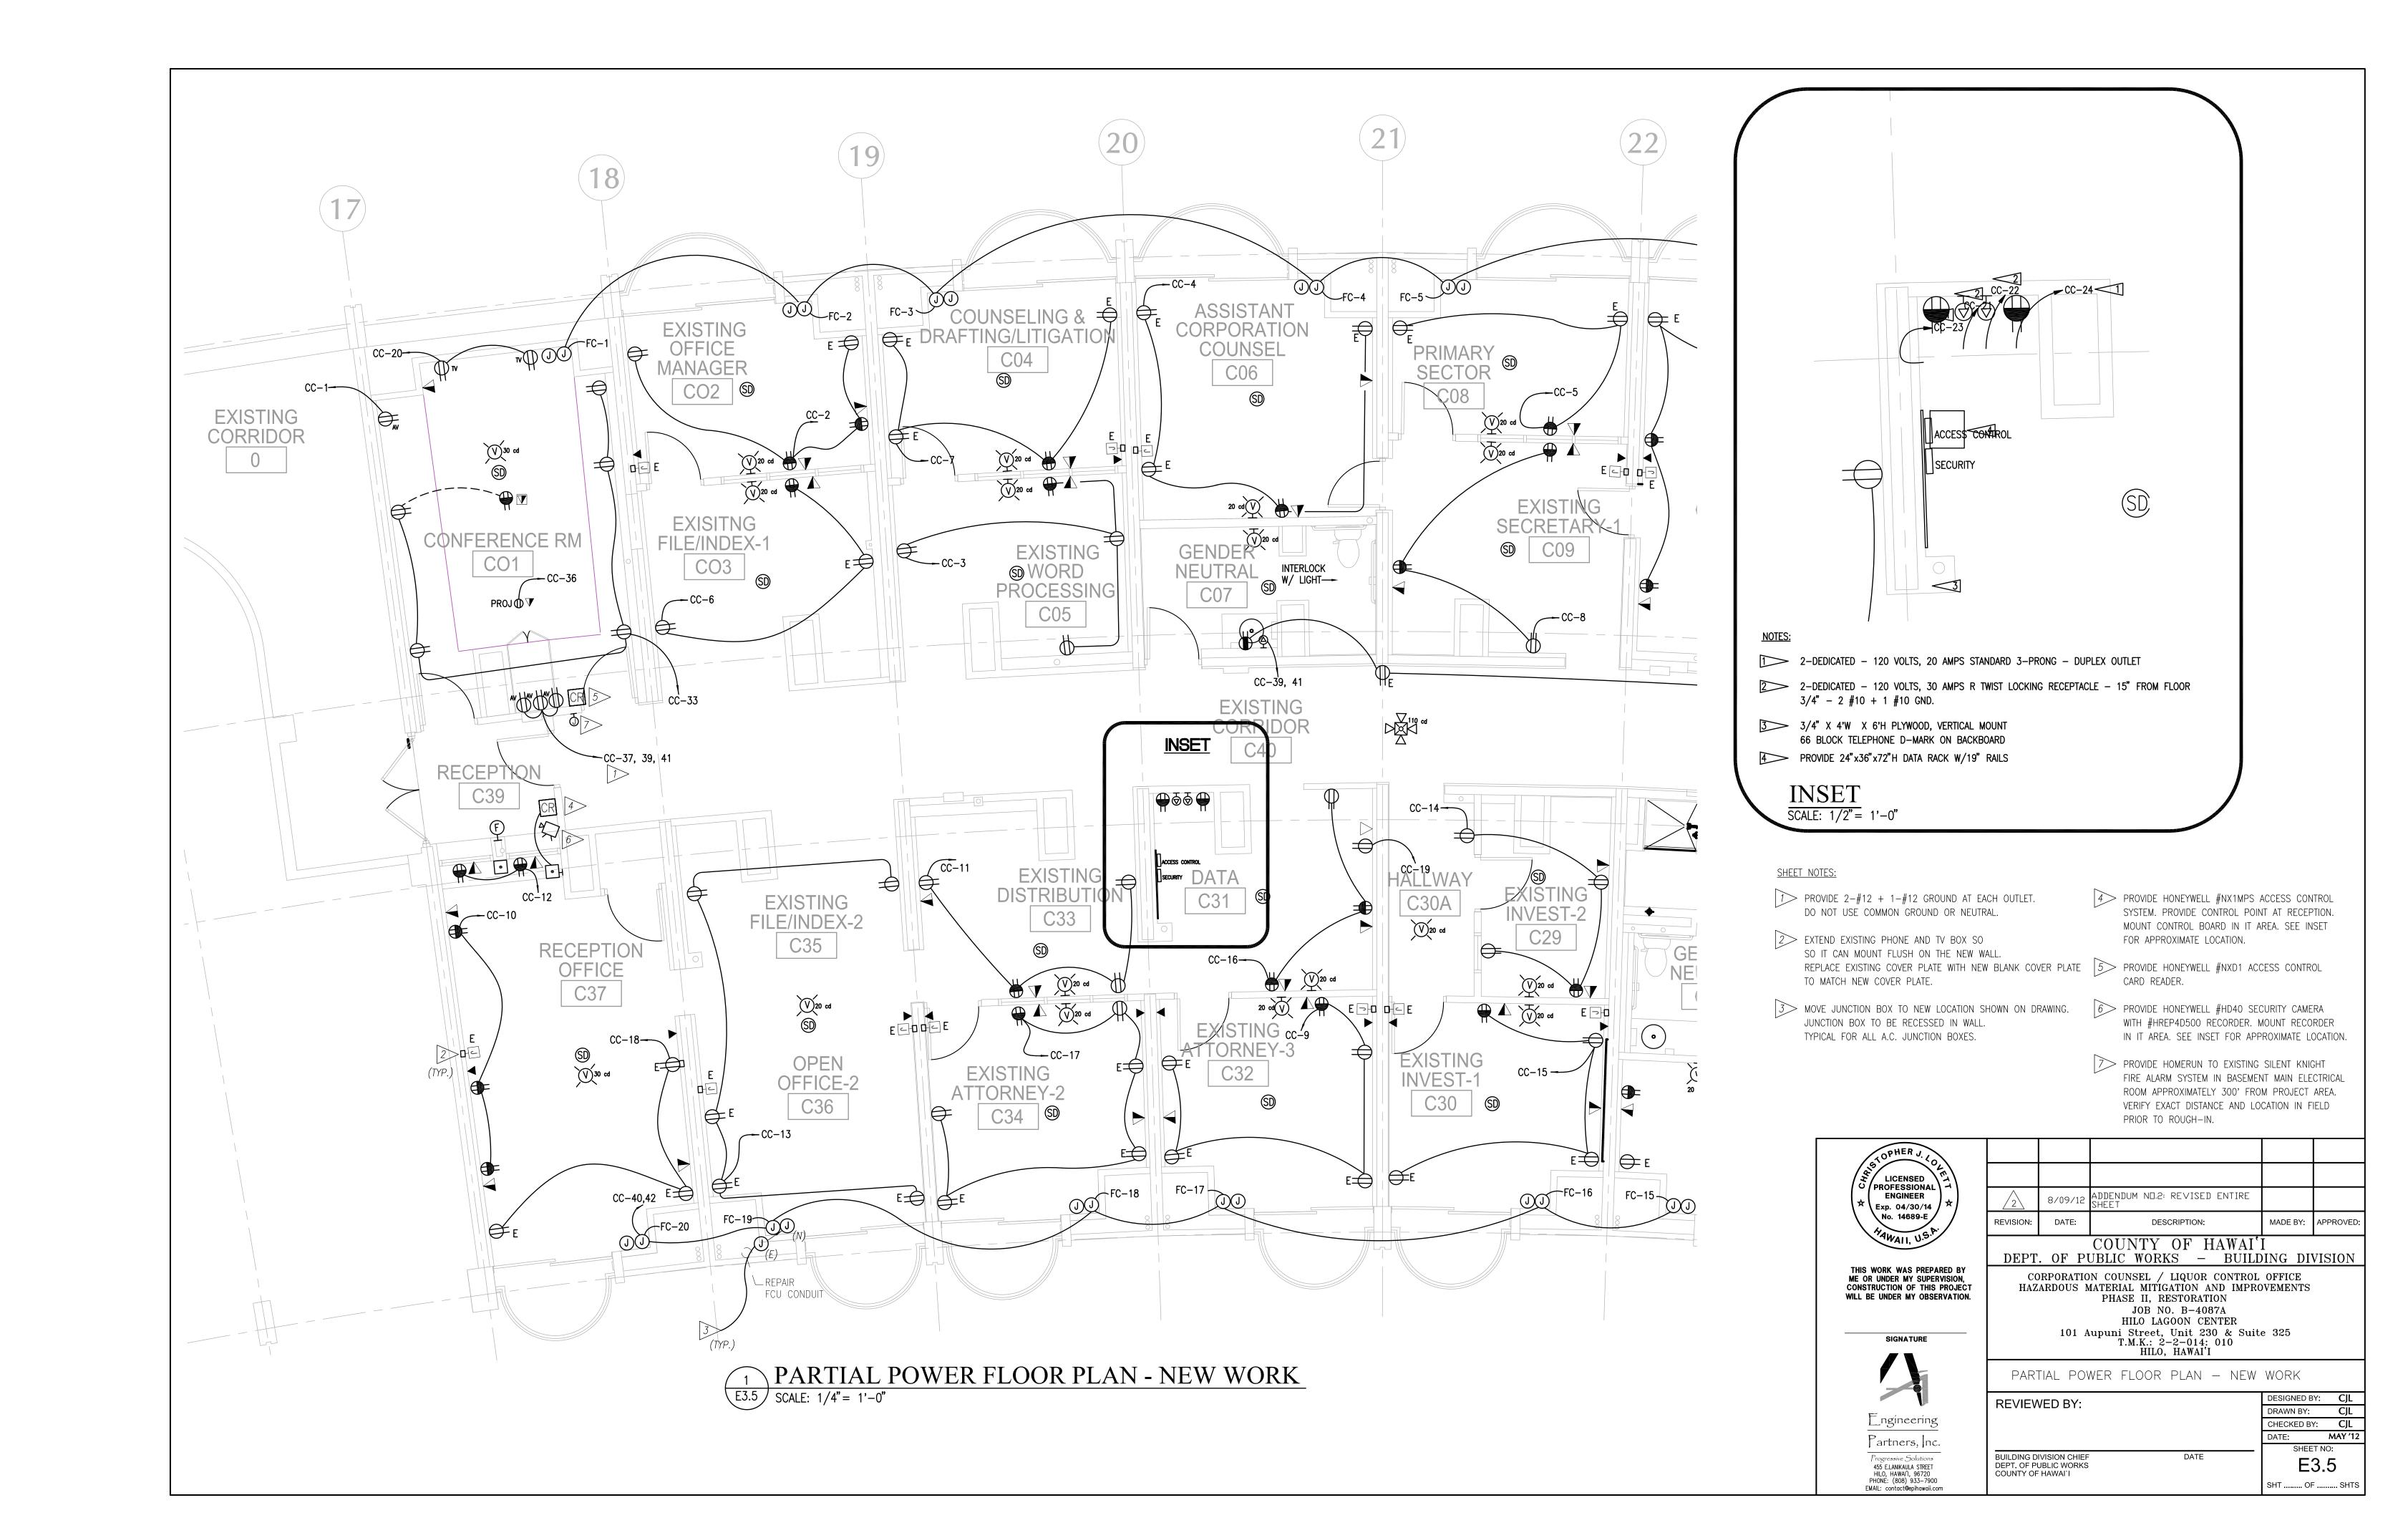

NOTES

DEMO ALL EXISTING LIGHTING, POWER, TELE/DATA, ETC. DEVICES IN THIS AREA. RETURN LIGHTING FIXTURES TO OWNER FOR REUSE.

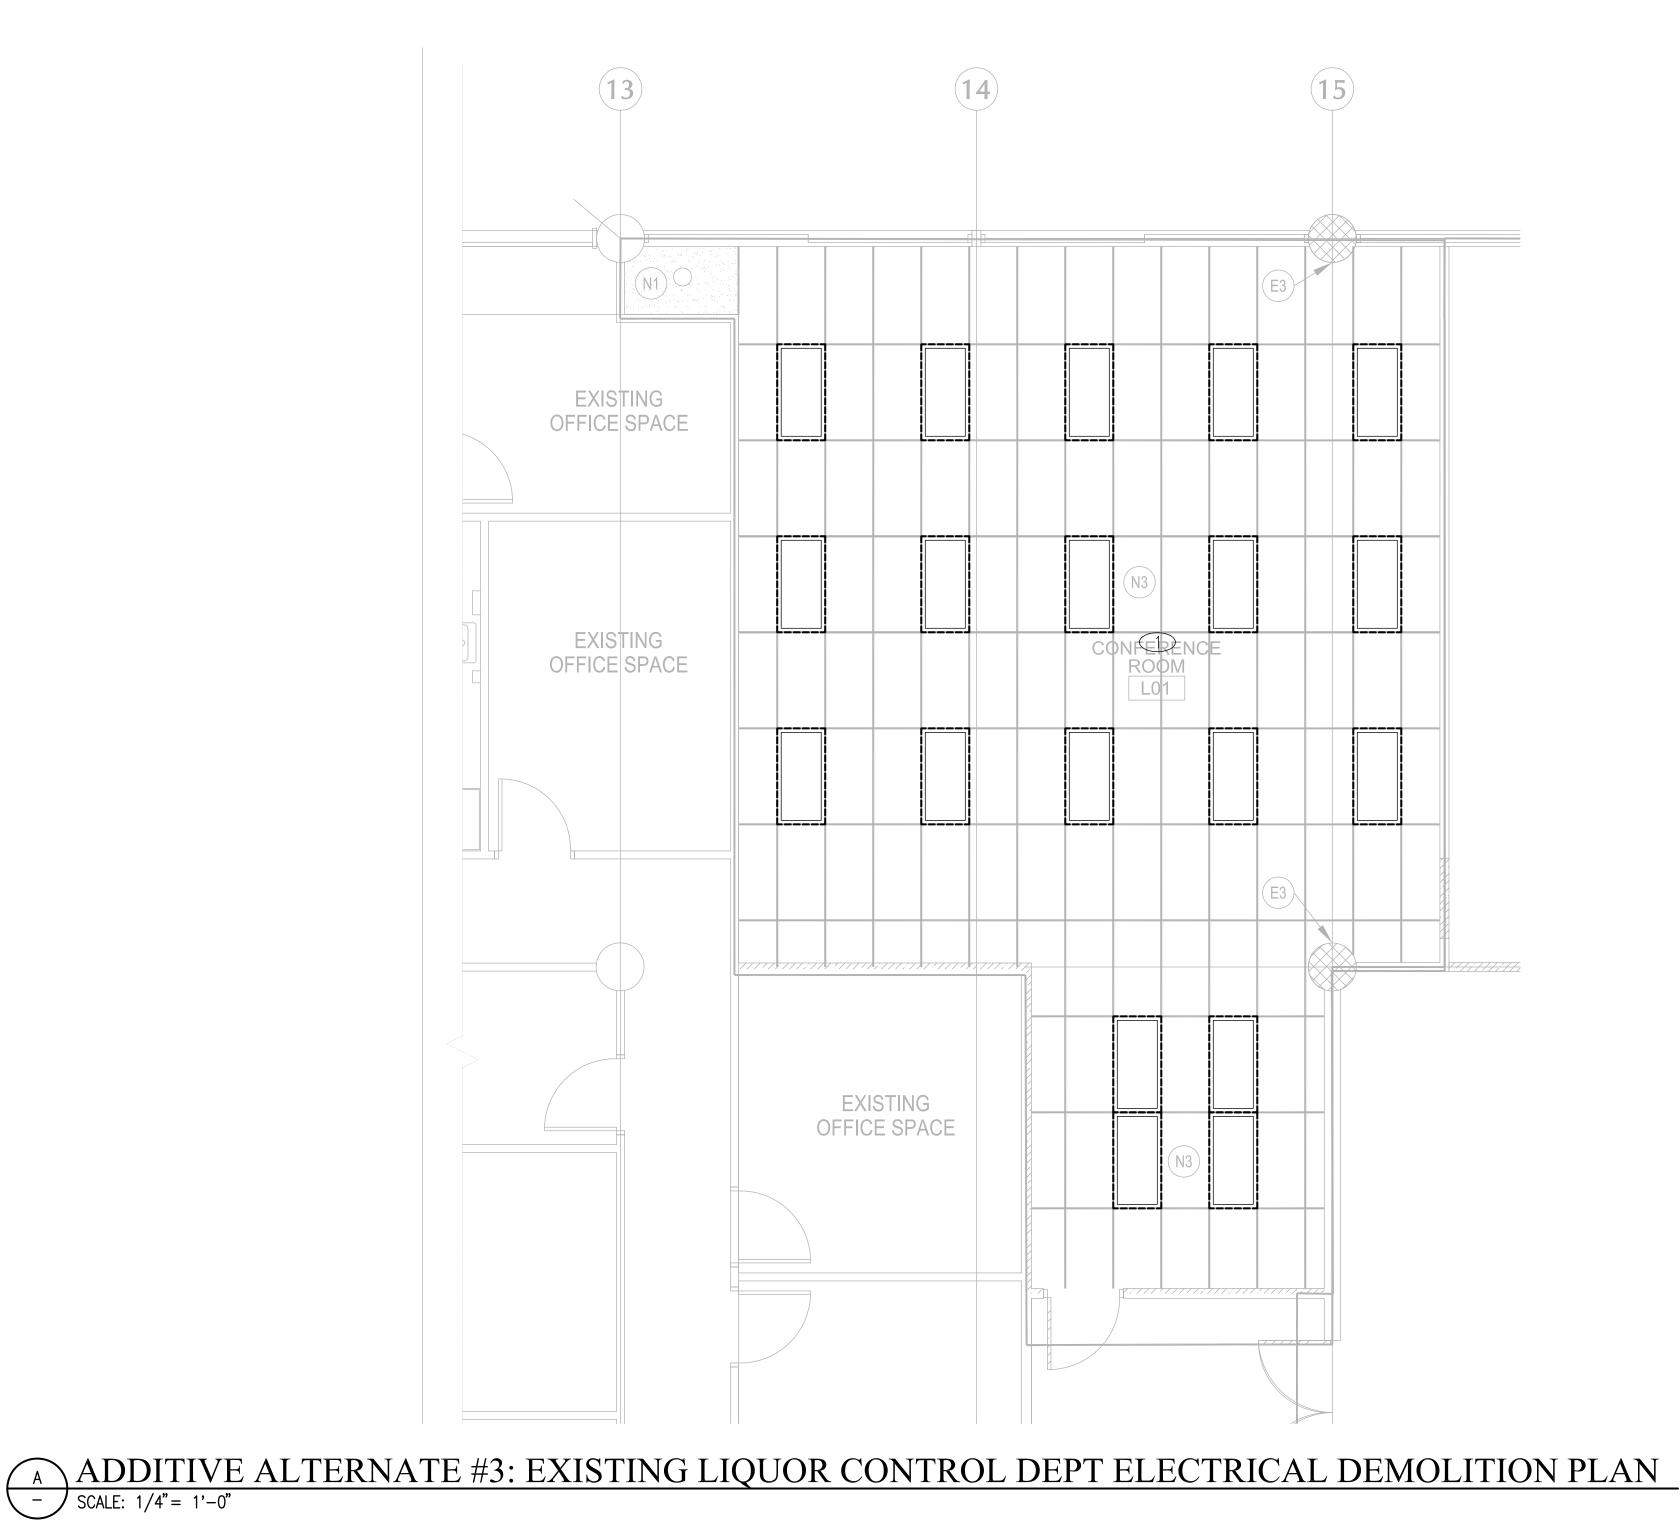

LICENSED PROFESSIONAL ENGINEER Exp. 04/30/14
No. 14689-E

THIS WORK WAS PREPARED BY ME OR UNDER MY SUPERVISION, CONSTRUCTION OF THIS PROJECT WILL BE UNDER MY OBSERVATION.

2	8/09/12	ADDENDUM NO.2: NEW SHEET		
REVISION:	DATE:	DESCRIPTION:	MADE BY:	APPROVED:
	·	COUNTY OF HAWAI'	r	

COUNTY OF HAWAI'I

DEPT. OF PUBLIC WORKS — BUILDING DIVISION

FOR MY SUPERVISION,

FOR MY SUPER PROJECT.

CORPORATION COUNSEL / LIQUOR CONTROL OFFICE
HAZARDOUS MATERIAL MITIGATION AND IMPROVEMENTS
PHASE II, RESTORATION
JOB NO. B-4087A
HILO LAGOON CENTER
101 Aupuni Street, Unit 230 & Suite 325
T.M.K.: 2-2-014: 010



ngineering	
artners, Inc.	
ogressive Solutions 55 E.LANIKAULA STREET ILO, HAWAII, 96720 DNE: (808) 933–7900	

HILO, HAWAI'I
ADDITIVE ALT 3/ EXISTING LIQUOR CONTROL DEPARTMENT ELECTRICAL
DEMOLITION PLAN
ı


REVIEWED BY:

DESIGNED BY: AM


DRAWN BY: MS

CHECKED BY: AM


		DATE:	AU(
		SHE	EET NO:
BUILDING DIVISION CHIEF DEPT. OF PUBLIC WORKS COUNTY OF HAWAII	DATE	E2.	.15
		SHT	OF

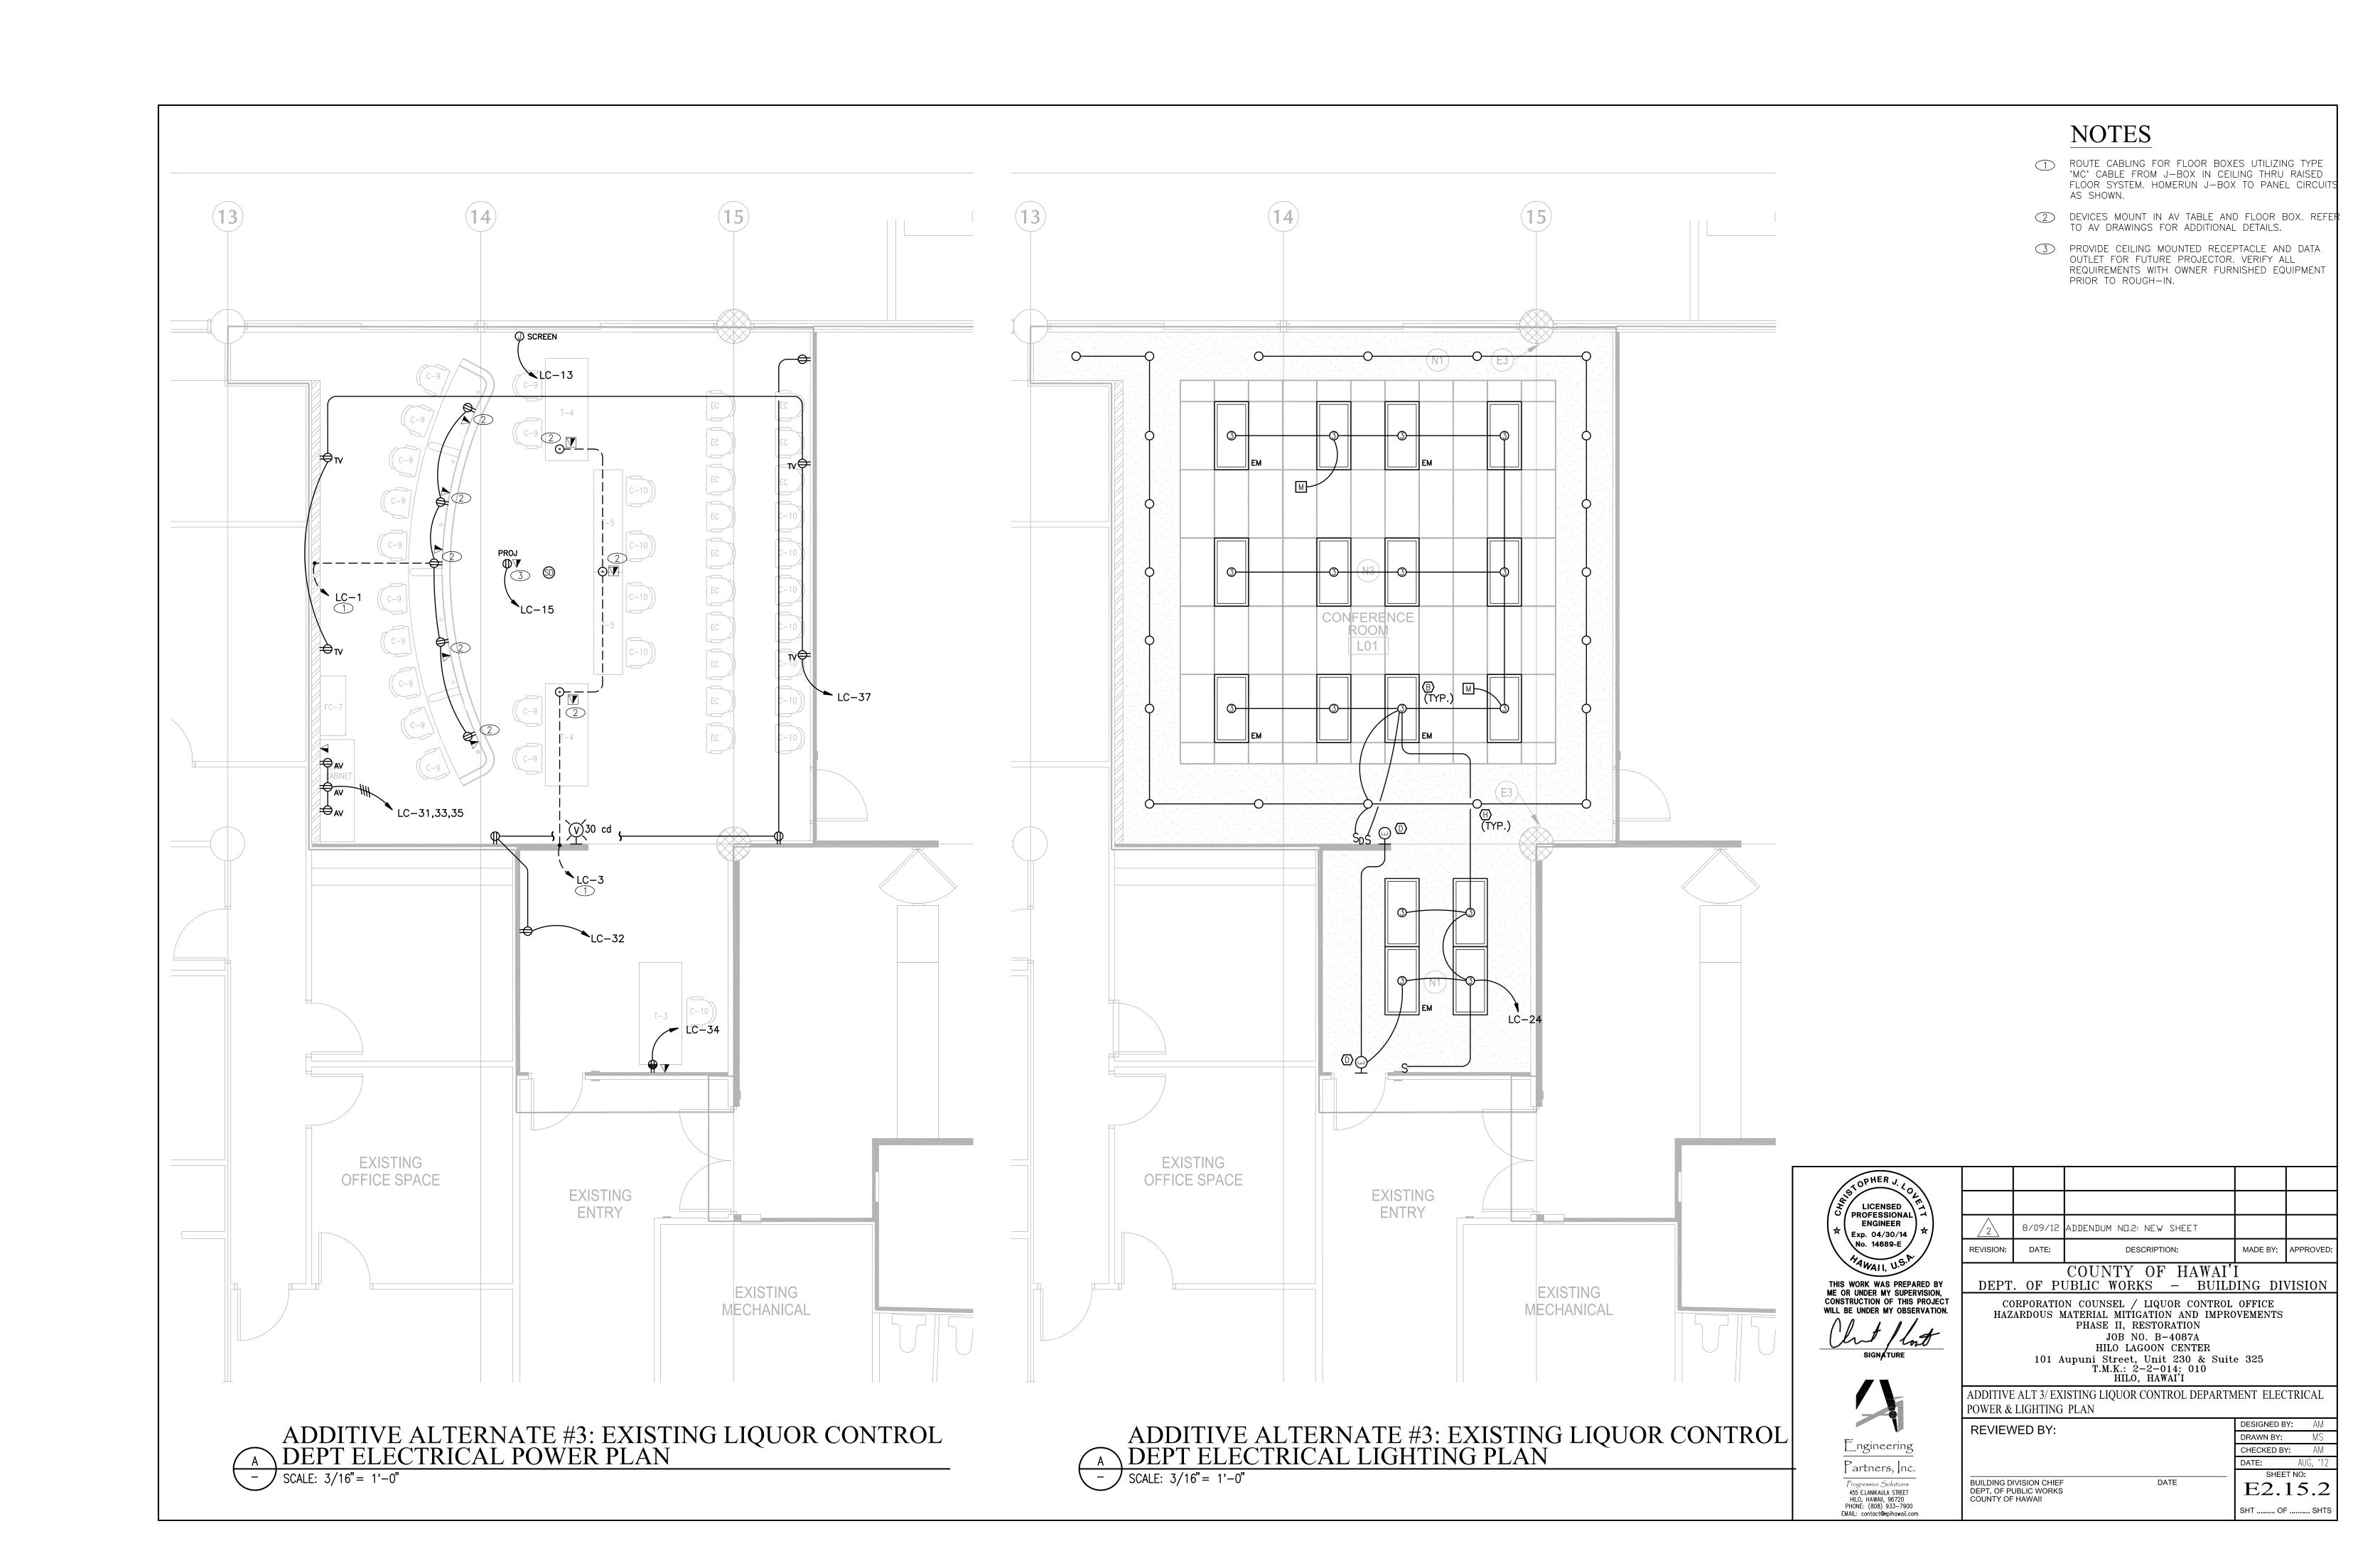

AV SYSTEM LEGEND

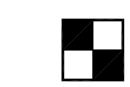



CORPORATION COUNSEL AV EQUIPMENT RACK. ELECTRICAL TO PROVIDE (3) 20A, 120VAC DEDICATED CIRCUITS, SINGLE PHASE WITH INDEPENDENT GROUNDS TO EACH RACK. TERMINATE CIRCUITS INTO ISOLATED GROUND DUPLEX OUTLETS INSIDE EQUIPMENT RACK. IT CONTRACTOR TO PROVIDE MINIMUM (1) DATA/LAN PORT IN RACK.

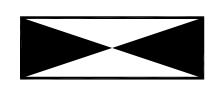


LIQUOR CONTROL CREDENZA STYLE EQUIPMENT RACK. ELECTRICAL TO PROVIDE (3) 20A, 120VAC DEDICATED CIRCUITS, SINGLE PHASE WITH INDEPENDANT GROUNDS. TERMINATE CIRCUITS INTO ISOLATED GROUND, DUPLEX OUTLETS IN WALL BEHIND RACK. IT CONTRACTOR TO PROVIDE MIN (2) DATA/LAN PORTS.

MOTORIZED PROJECTION SCREEN, FLUSH MOUNT IN CEILING. ELECTRICAL TO PROVIDE 120VAC POWER TO PROJECTION SCREEN MOTOR.

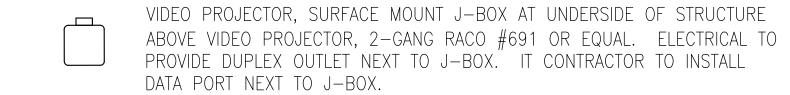


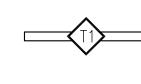

55" LCD MONITOR. ELECTRICAL CONTRACTOR TO INSTALL RECESSED BACK BOX PROVIDED BY AV CONTRACTOR. COORDINATE EXACT BACK BOX LOCATION WITH AV CONTRACTOR. ELECTRICAL CONTRACTOR TO PROVIDE DUPLEX NEXT TO RECESSED BACK BOX.

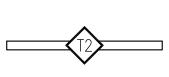

80" LCD MONITOR. ELECTRICAL CONTRACTOR TO INSTALL (2) RECESSED BACK BOXES PROVIDED BY AV CONTRACTOR. COORDINATE EXACT BACK BOX LOCATION WITH AV CONTRACTOR. ELECTRICAL CONTRACTOR TO PROVIDE DUPLEX NEXT TO RECESSED BACK BOX. REFER TO LCD MOUNTING DETAIL ON DRAWING AV 4.3 FOR MORE INFORMATION.

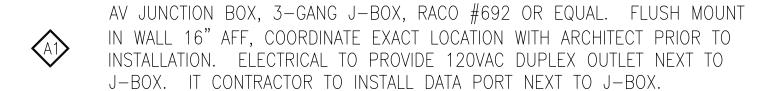

COUNSEL TABLE TOP CABLE BOX. COORDINATE EXACT LOCATION WITH




- AV CONTROL TOUCHPANEL WALL-MOUNTED DOCKING STATION. ELECTRICAL CONTRACTOR TO INSTALL BACKBOX PROVIDED BY AV CONTRACTOR. FLUSH MOUNT IN WALL 54" AFF.
- CORPORATION COUNSEL FRONT WALL VIDEO CAMERA. 2-GANG J-BOX, RACO #691 OR EQUAL. FLUSH MOUNT J-BOX IN WALL BEHIND CAMERA. SURFACE MOUNT CAMERA DIRECTLY ABOVE LCD MONITORS AT THE FRONT WALL.
- CORPORATION COUNSEL BACK WALL VIDEO CAMERA. ELECTRICAL CONTRACTOR TO INSTALL CUSTOM SEMI-RECESSED BACK BOX PROVIDED BY AV CONTRACTOR. MOUNT BOX 1" BELOW CEILING TO THE TOP OF BACK
- LIQUOR CONTROL VIDEO CAMERA. ELECTRICAL CONTRACTOR TO INSTALL CUSTOM SEMI-RECESSED BACK BOX PROVIDED BY AV CONTRACTOR. MOUNT BOX 80" TO BOTTOM OF CAMERA.
- CEILING-MOUNTED DOCUMENT CAMERA. MOUNT CAMERA IN ACT GRID CEILING. COORDINATE EXACT LOCATION WITH ARCHITECT AND FURNITURE INSTALLER. ELECTRICAL TO MOUNT 2-GANG J-BOX ON UNDERSIDE OF STRUCTURE ABOVE DOCUMENT CAMERA FOR ROUTING AV CONNECTIONS.
- CORPORATION COUNSEL FLOOR-MOUNT RACEWAY BOX. ELECTRICAL TO PROVIDE POWER TO PRE-WIRED RACEWAY. IT CONTRACTOR TO PROVIDE
- CEILING LOUDSPEAKER, FLUSH-MOUNT IN ACT GRID CEILING.

FLAG NOTES

TO CORPORATION COUNSEL AV EQUIPMENT RACKS (




2 TO LIQUOR CONTROL AV EQUIPMENT RACK (

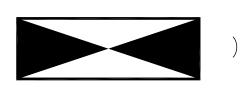

GENERAL NOTES

- 1. ALL CONDUIT IS 3/4" EMT UNLESS NOTED OTHERWISE.
- 2. ALL CONDUIT SHALL BE METALLIC TYPE ONLY, NO PVC SHALL BE USED. CONDUIT IN SLAB MUST BE PVC COATED METALLIC TYPE OR APPROVED EQUIVALENT.
- 3. LOCATIONS OF WALL-MOUNTED EQUIPMENT RACKS AND JUNCTION BOXES ARE TO CENTERLINE OF DEVICE UNLESS NOTED OTHERWISE. EQUIPMENT LOCATIONS SHALL BE COORDINATED WITH THE ELECTRICAL CONTRACTOR PRIOR TO INSTALLATION.
- 4. ALL ELECTRICAL/JUNCTION BOXES PROVIDED AND INSTALLED BY ELECTRICAL CONTRACTOR UNLESS NOTED OTHERWISE.
- 5. LOUDSPEAKER LEVEL CABLE IS NOT TO BE BUNDLED WITH LINE/MICROPHONE LEVEL AUDIO CABLE, NETWORK CABLE, OR VIDEO CABLE.
- STANDARD VOLTAGE LINES SHALL NOT BE PARALLEL TO AV SYSTEMS CABLE WHEN WITHIN 4'.
- 7. ELECTRICAL CONTRACTOR TO COORDINATE ALL NEW CONDUIT RUNS WITH AV CONTRACTOR SUCH THAT CONDUIT IS THE MOST DIRECT AS POSSIBLE AND NO SIGNAL PATH IS BEYOND THE OPERATING LIMITS FOR ANY SIGNAL. ALL COORDINATION TO BE DOCUMENTED, DATED, AND SIGNED OFF BY BOTH AV AND ELECTRICAL CONTRACTORS.
- 8. CONDUIT BENDS SHALL NOT EXCEED 180° BETWEEN PULL BOXES.

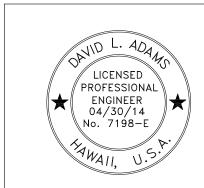

2	8/09/12	ADDENDUM NO.2		
REVISION:		DESCRIPTION:	MADE BY:	APPROVED:

COUNTY OF HAWAI'I

CORPORATION COUNSEL / LIQUOR CONTROL OFFICE HAZARDOUS MATERIAL MITIGATION AND IMPROVEMENTS PHASE II, RESTORATION JOB NO. B-4087A HILO LAGOON CENTER ∠30 & Suite 325 T.M.K.: 2-2-014: 010


AV SYSTEM LEGEND

REVIEWED BY:

DEPT. OF PUBLIC WORKS

SHEET NO: **AV 1.1**



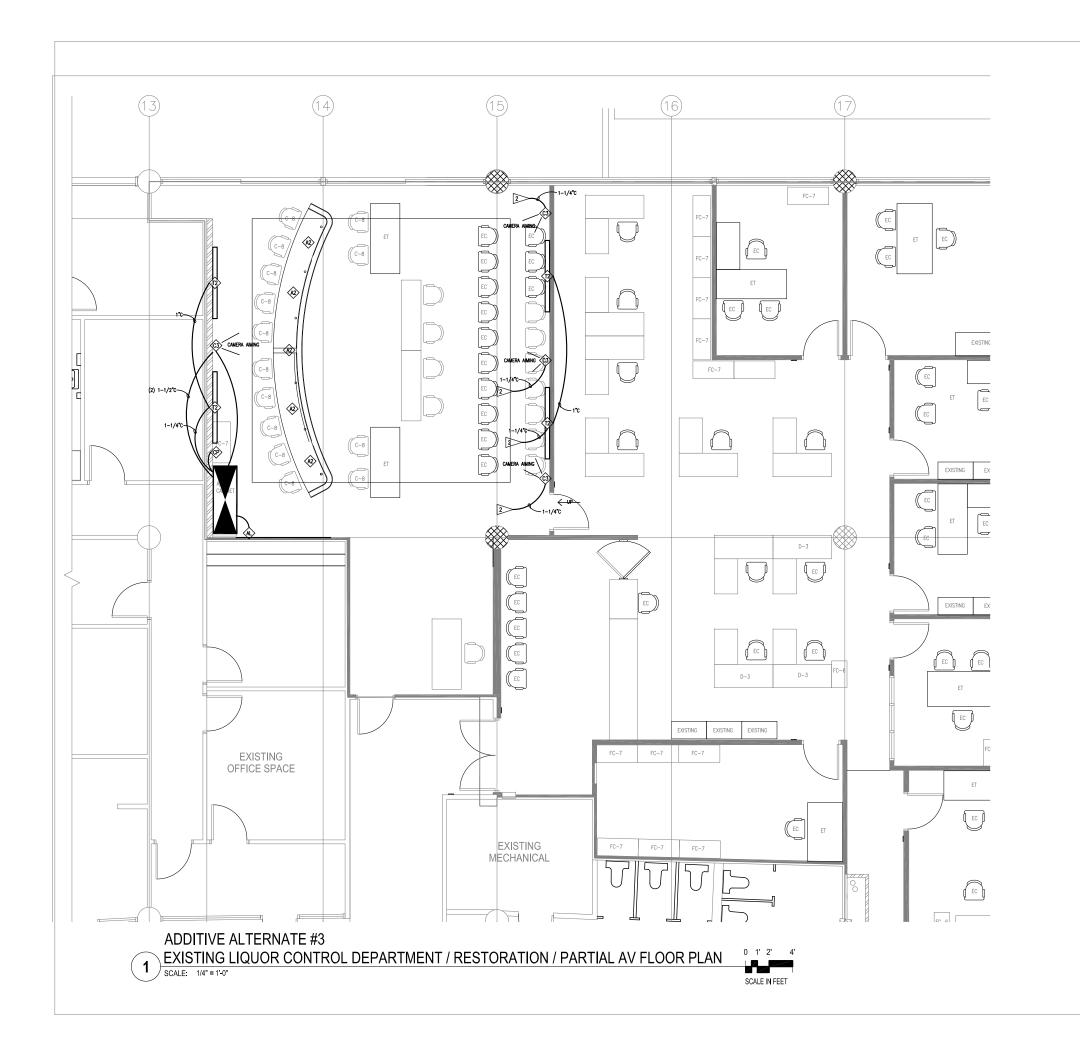




2	8/09/12	ADDENDUM NO.2: REVISED ENTIRE SHEET		
REVISION:	DATE:	DESCRIPTION:	MADE BY:	APPROVED:
	•	-		•

COUNTY OF HAWAI'I
DEPT. OF PUBLIC WORKS - BUILDING DIVISION

CORPORATION COUNSEL / LIQUOR CONTROL OFFICE
HAZARDOUS MATERIAL MITIGATION AND IMPROVEMENTS
PHASE II, RESTORATION
JOB NO. B. -4087A
HILO LAGOON CENTER
101 Aupuni Street, Unit 230 & Suite 325
T.M.K.: 2-2-014; 010
HILO, HAWAI'I

EXISTING LIQUOR CONTROL DEPARTMENT/RESTORATION PARTIAL AV FLOOR PLAN REVIEWED BY:

DRAWN BY: APD
CHECKED BY: GLM
DATE: AUG '12
SHEET NO: **AV 2.1**

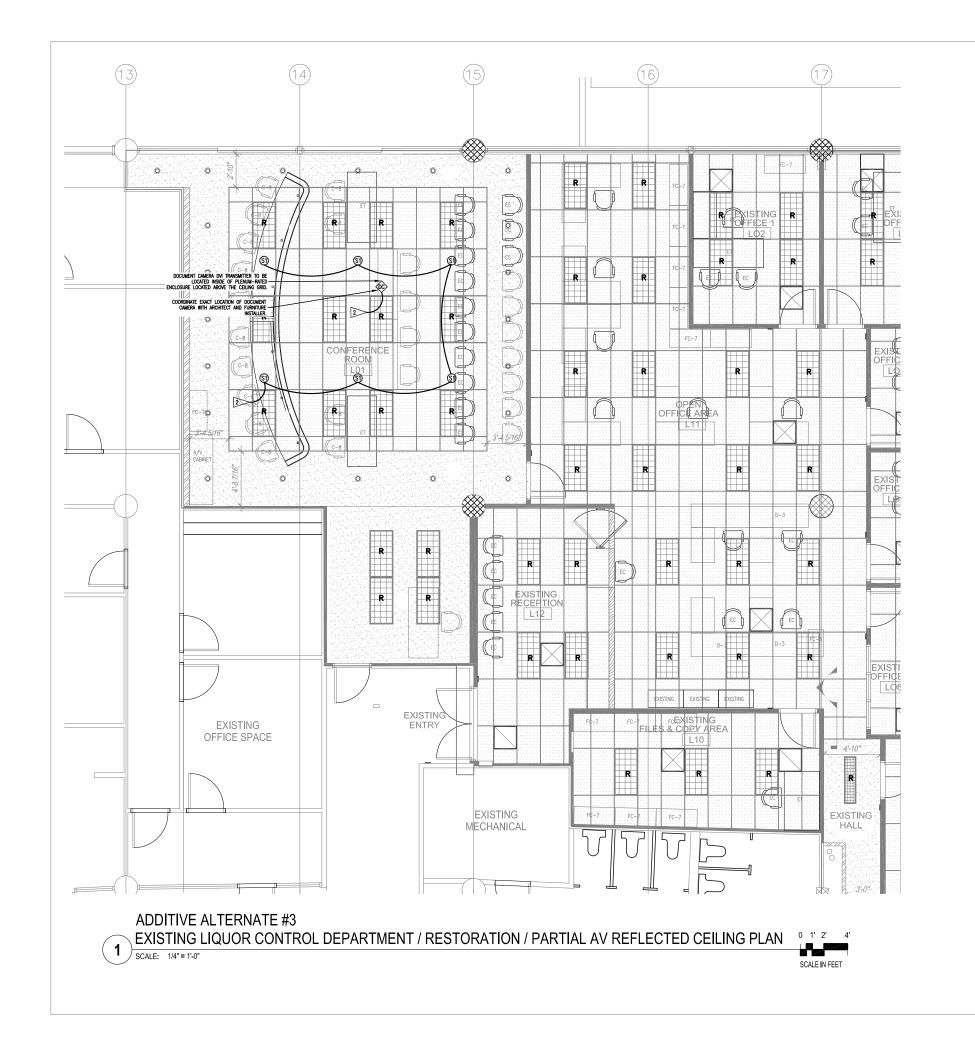



THIS WORK WAS PREPARED BY ME OR UNDER IN SUPERFASION, AND CONSTRUCTION OF THIS PROJECT WILL BE UNDER MY ORSERVATION. OBSERVATION, OBSERVATION AS DETAILED IN CHAPTER 16-115. THE HAWAII ADMINISTRATURE RULES, DEPT, OF COMMERCE AND CONSUMER AFFARS, ENTITLEE PROFESSIONAL ENGINEERS, ARCHITECTS, SURVEYORS, AND LANGSCAPED ARCHITECTS.

2	8/09/12	ADDENDUM NO.2: REVISED ENTIRE SHEET		
REVISION:	DATE:	DESCRIPTION:	MADE BY:	APPROVED:

COUNTY OF HAWAI'I
DEPT. OF PUBLIC WORKS - BUILDING DIVISION

CORPORATION COUNSEL / LIQUOR CONTROL OFFICE
HAZARDOUS MATERIAL MITIGATION AND IMPROVEMENTS
PHASE II, RESTORATION
JOB NO. B-4087A
HILO LAGOON CENTER
101 Aupuni Street, Unit 230 & Suite 325
T.M.K.: 2-2-2014; 010
HLO, HAWAI'I

EXISTING LIQUOR CONTROL DEPARTMENT/RESTORATION PARTIAL AV REFLECTED CEILING PLAN


REVIEWED BY:


DRAWN BY: APD CHECKED BY: GLM DATE: AUG '12 SHEET NO:


AV 2.2



SHT OF SHTS

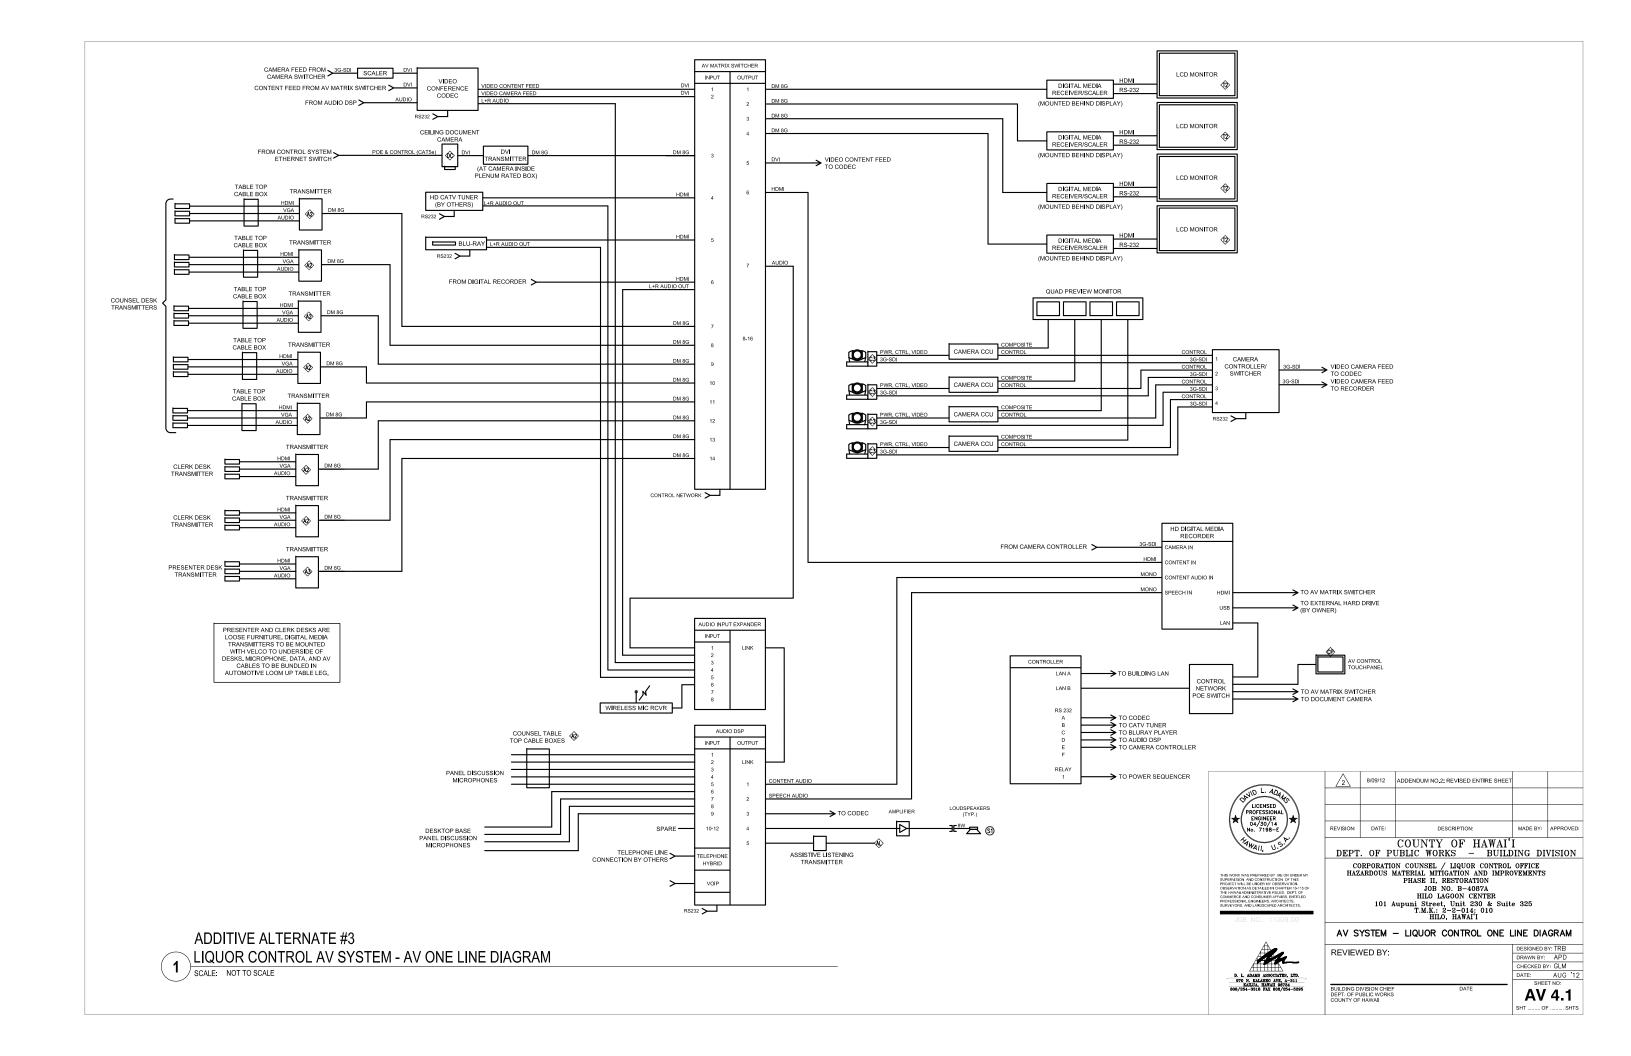

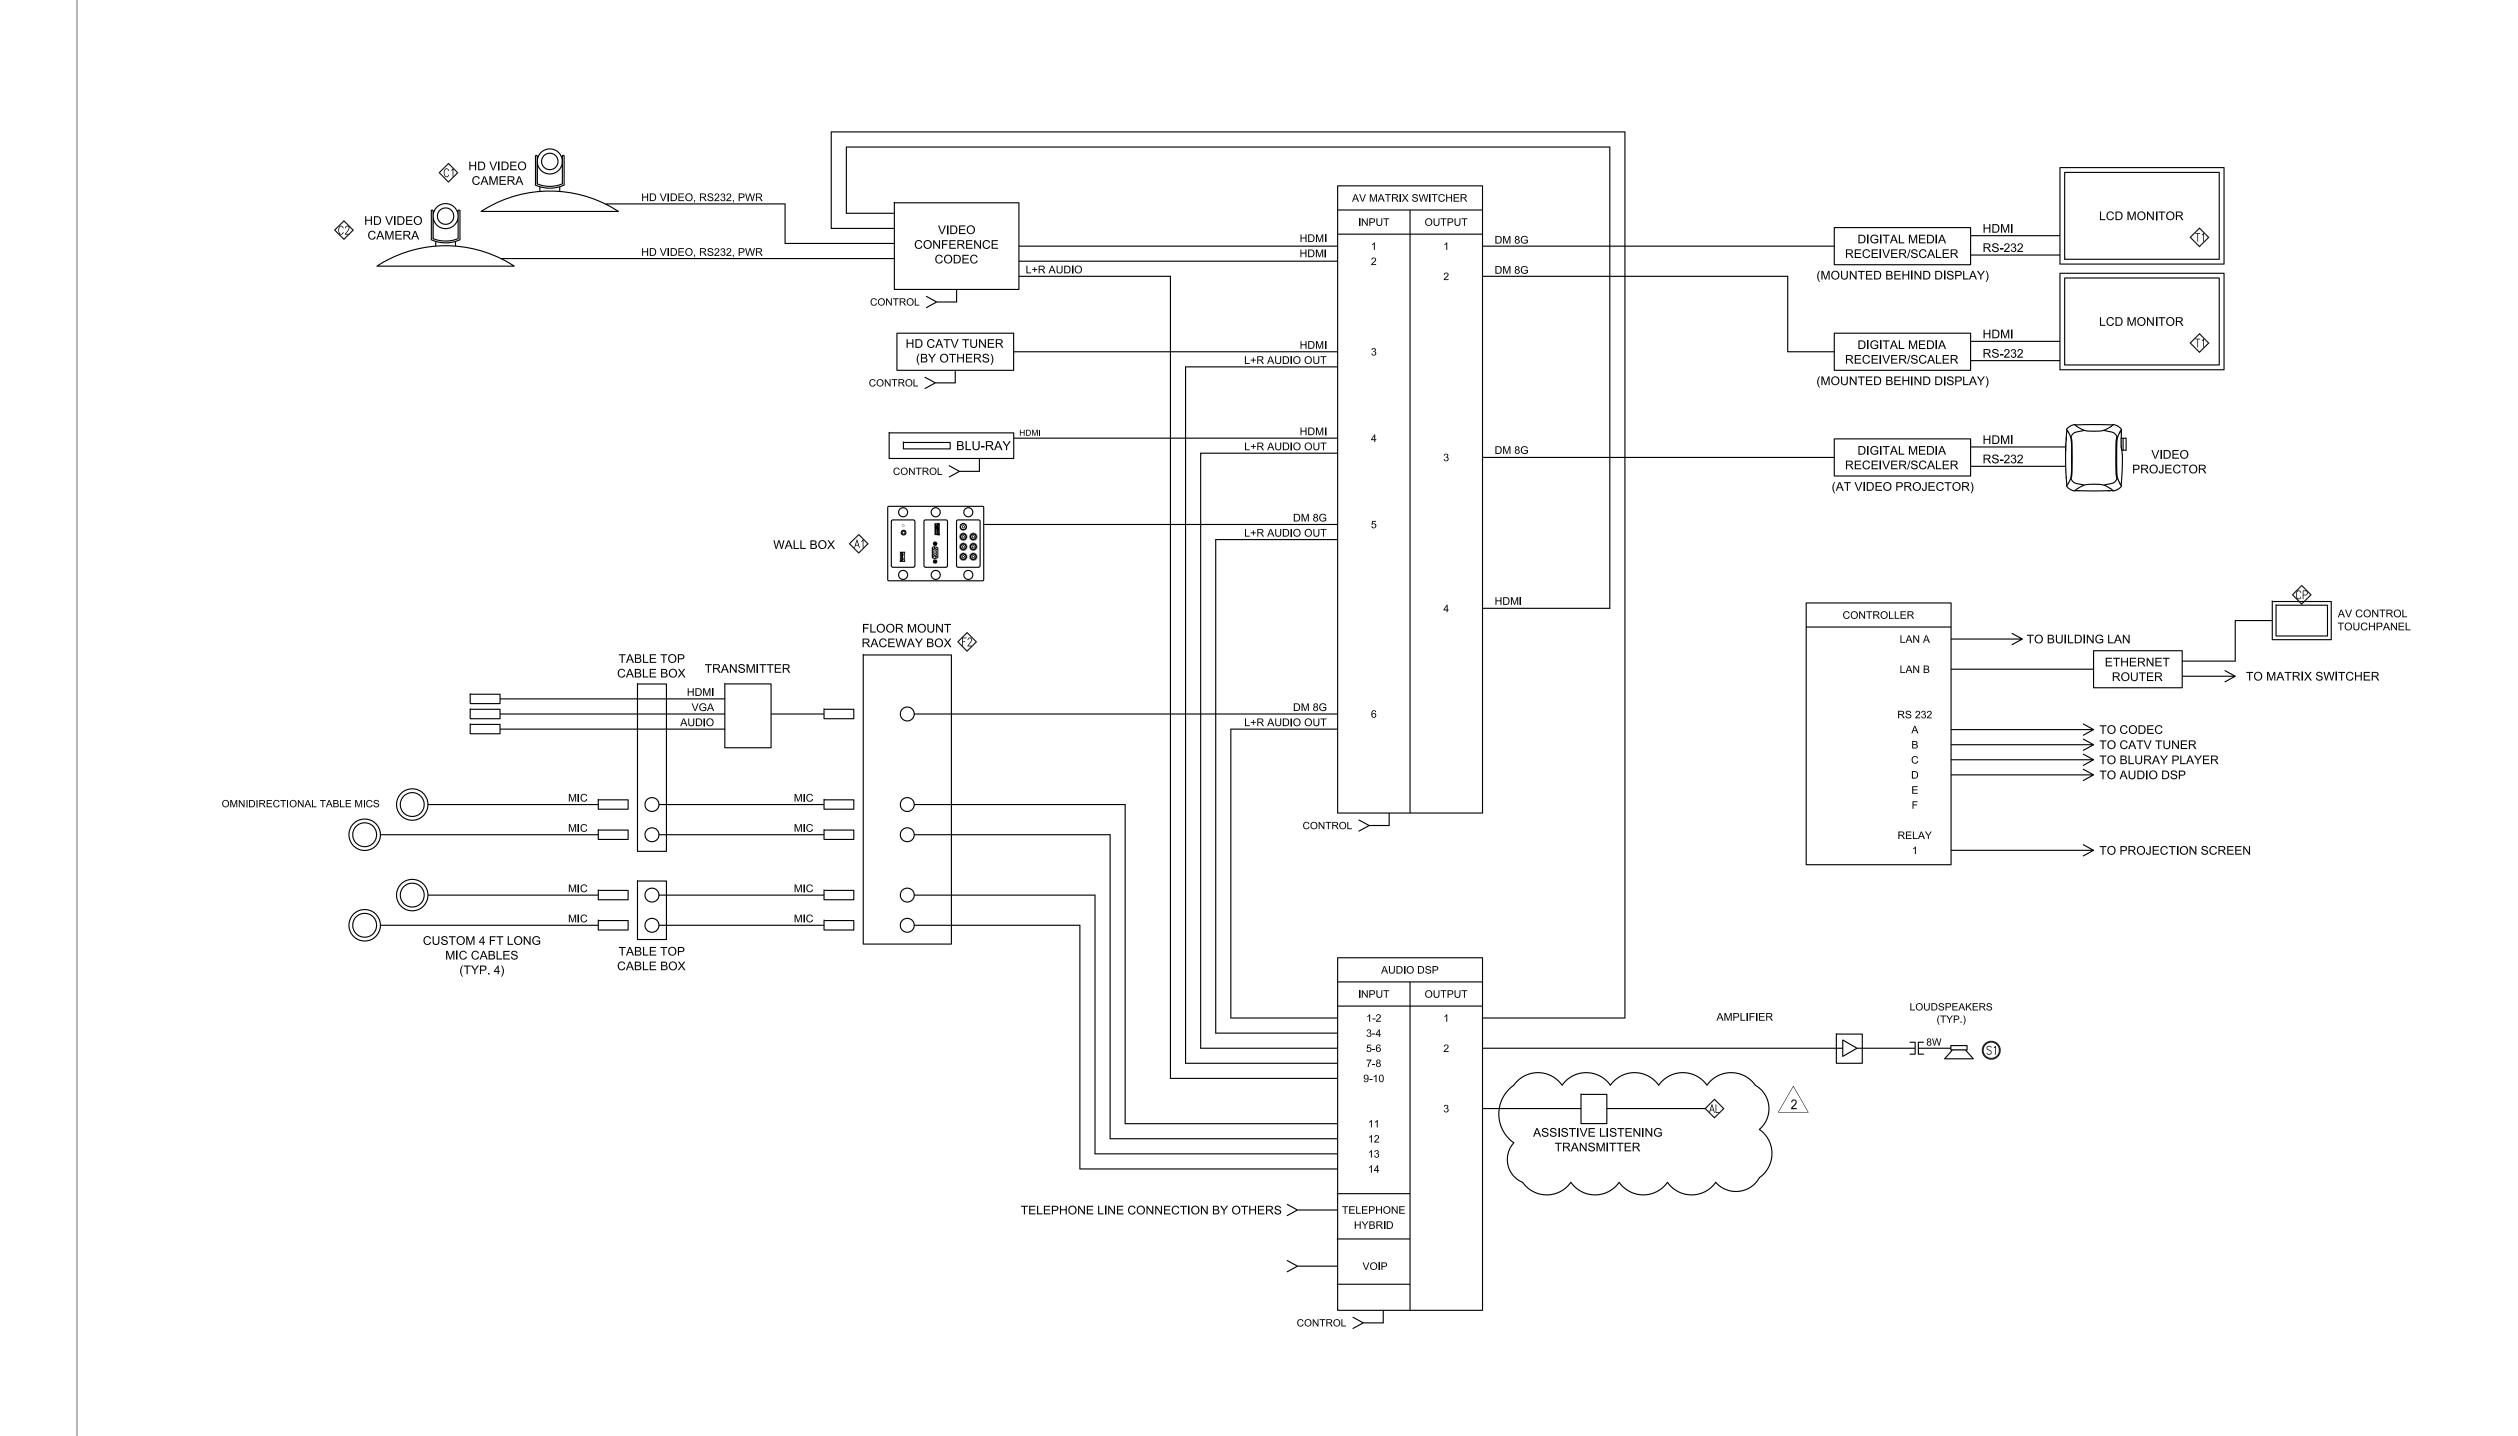

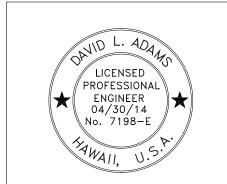


THIS WORK WAS PREPARED BY ME OR UNDER MY SUPERVISION AND CONSTRUCTION OF THIS PROJECT WILL BE UNDER MY OBSERVATION. OBSERVATION AS DETAILED IN CHAPTER 16-115 OF THE HAWAII ADMINISTRATIVE RULES, DEPT. OF COMMERCE AND CONSUMER AFFAIRS, ENTITLED PROFESSIONAL ENGINEERS, ARCHITECTS, SURVEYORS, AND LANDSCAPED ARCHITECTS.

8/09/12 ADDENDUM NO.2 MADE BY: APPROVED: REVISION: DATE: DESCRIPTION: COUNTY OF HAWAI'I

DEPT. OF PUBLIC WORKS - BUILDING DIVISION CORPORATION COUNSEL / LIQUOR CONTROL OFFICE HAZARDOUS MATERIAL MITIGATION AND IMPROVEMENTS PHASE II, RESTORATION JOB NO. B-4087A HILO LAGOON CENTER

101 Aupuni Street, Unit 230 & Suite 325 T.M.K.: 2-2-014: 010 HILO, HAWAI'I

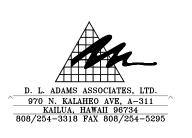

D. L. ADAMS ASSOCIATES, LTD. 970 N. KALAHEO AVE, A-311
970 N. KALAHEO AVE, A-311
KAILUA, HAWAII 96734
808/254-3318 FAX 808/254-5295

AV SYSTEM - CORPORATION COUNSEL ONE LINE DIAGRAM

REVIEWED BY:


DESIGNED BY: TRB DRAWN BY: APD CHECKED BY: GLM DATE: AUG '1 SHEET NO:


BUILDING DIVISION CHIEF DEPT. OF PUBLIC WORKS COUNTY OF HAWAII

CORPORATION COUNSEL AV SYSTEM - AV ONE LINE DIAGRAM


DATE

AV 4.2 SHT OF SHTS

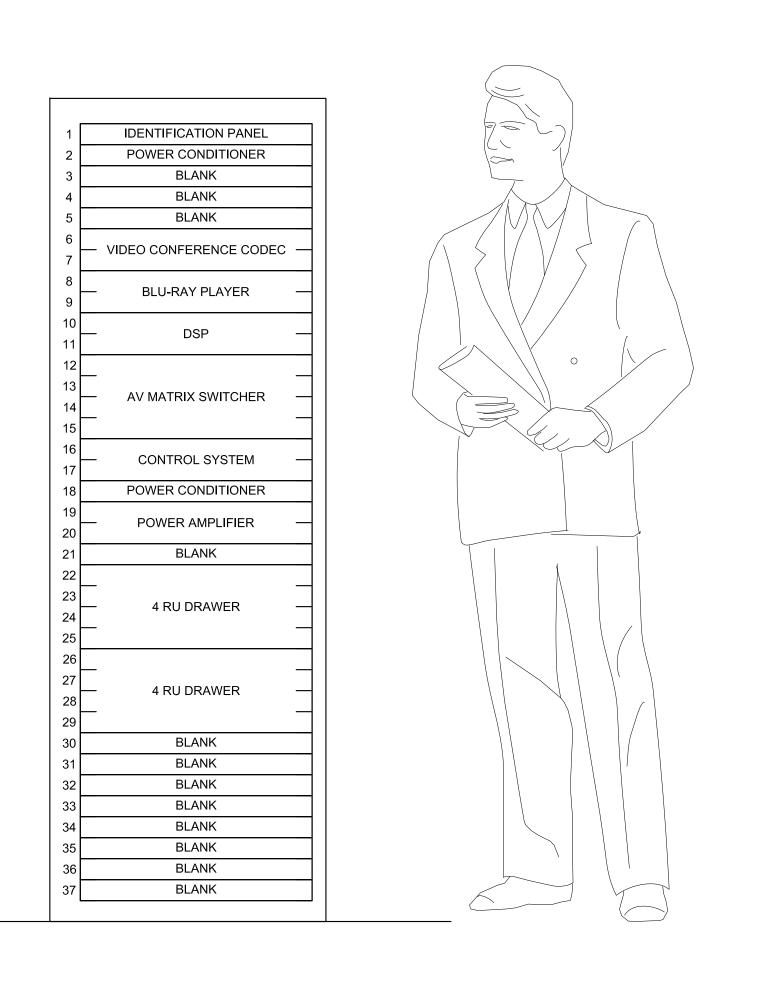

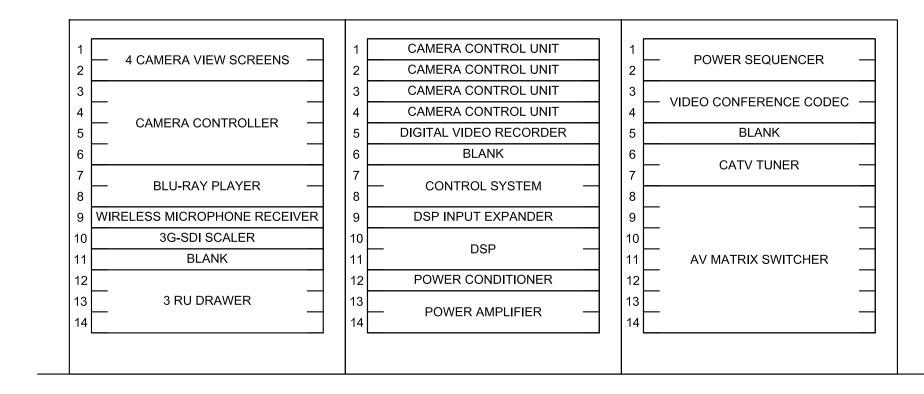


COORDINATE EXACT LOCATION OF ALL WALL BOXES WITH AV CONTRACTOR PRIOR TO INSTALLATION.

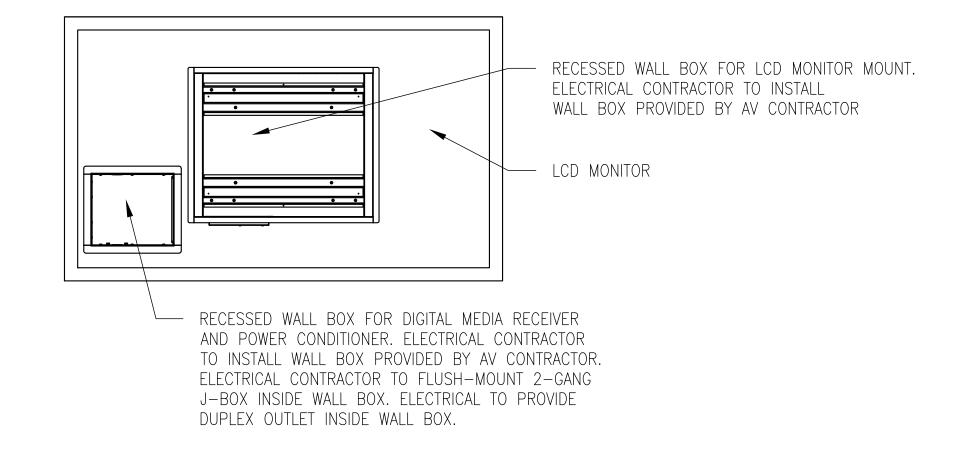


CORPORATION COUNSEL AV SYSTEM - AV RACK LAYOUT SCALE: 1-1/2" = 1'-0"





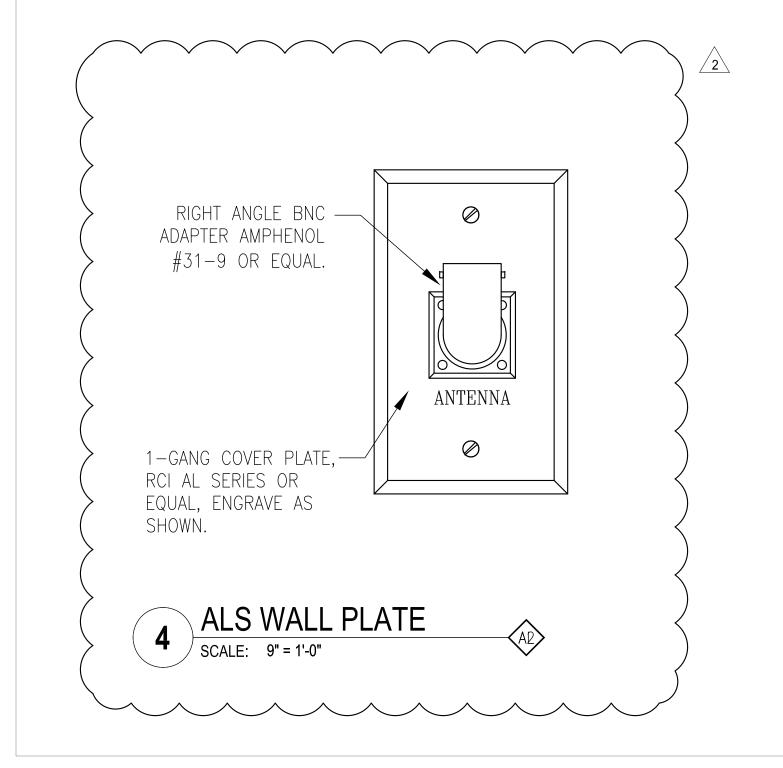

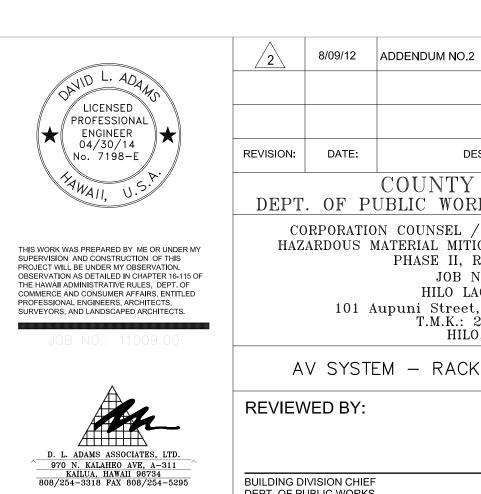


BUILDING DIVISION CHIEF DEPT. OF PUBLIC WORKS COUNTY OF HAWAII


MADE BY: APPROVED: DESCRIPTION: COUNTY OF HAWAI'I DEPT. OF PUBLIC WORKS - BUILDING DIVISION CORPORATION COUNSEL / LIQUOR CONTROL OFFICE HAZARDOUS MATERIAL MITIGATION AND IMPROVEMENTS PHASE II, RESTORATION JOB NO. B-4087A HILO LAGOON CENTER 101 Aupuni Street, Unit 230 & Suite 325 T.M.K.: 2-2-014: 010 HILO, HAWAI'I AV SYSTEM - RACK LAYOUTS AND DETAILS **DESIGNED BY:** TRB REVIEWED BY: DRAWN BY: APD CHECKED BY: GLM


DATE

DATE: AUG '12 SHEET NO:

AV 4.3 SHT OF SHTS

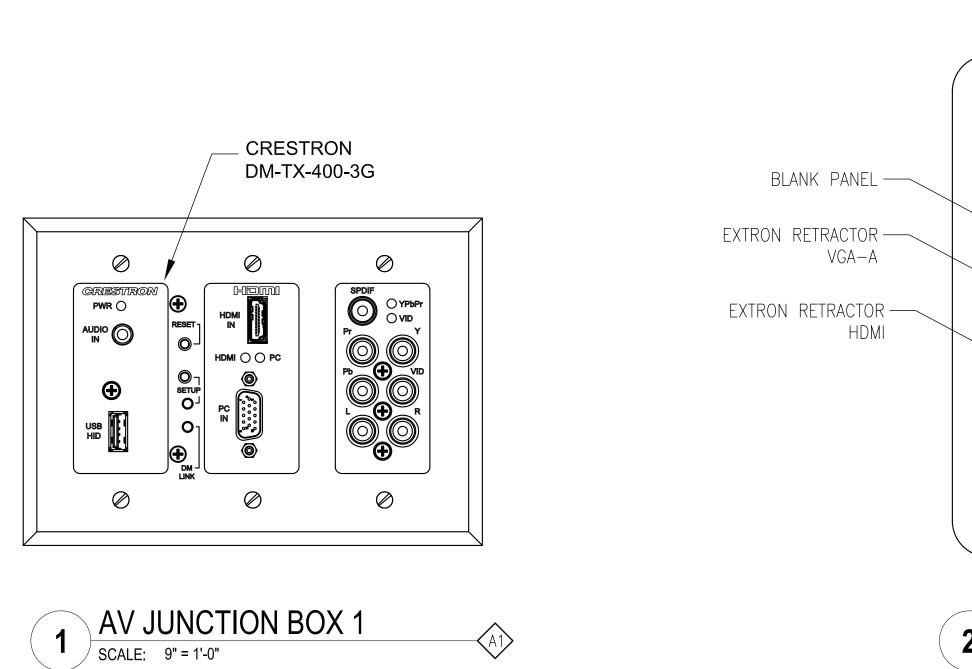

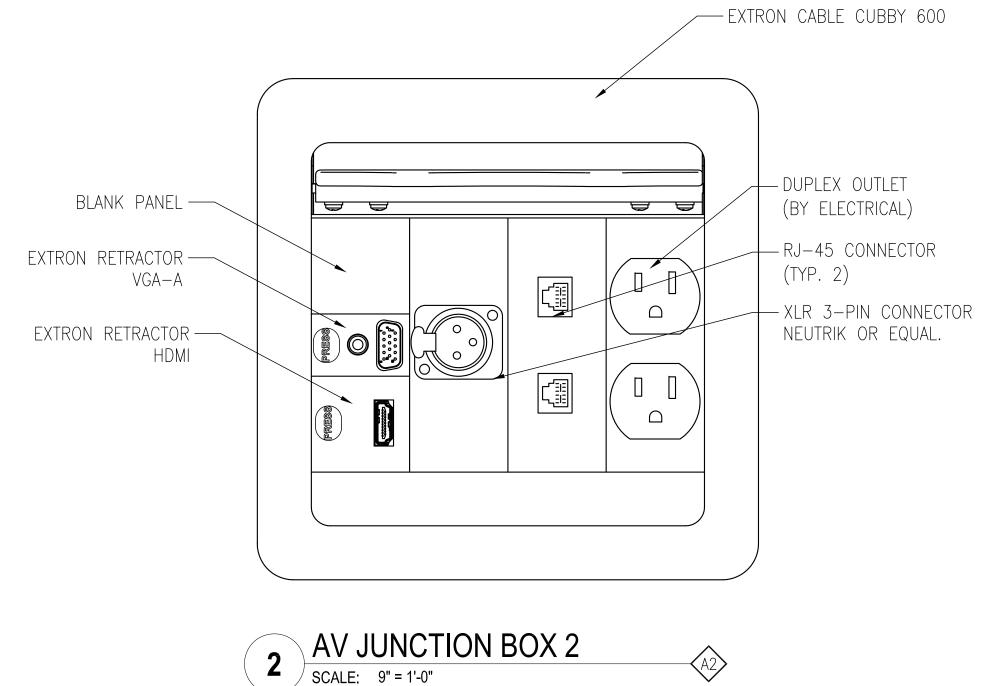

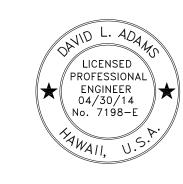

THIS WORK WAS PREPARED BY ME OR UNDER MY SUPERVISION AND CONSTRUCTION OF THIS PROJECT WILL BE UNDER MY OBSERVATION. OBSERVATION AS DETAILED IN CHAPTER 16-115 OF THE HAWAII ADMINISTRATIVE RULES, DEPT. OF COMMERCE AND CONSUMER AFFAIRS, ENTITLED PROFESSIONAL ENGINEERS, ARCHITECTS, SURVEYORS, AND LANDSCAPED ARCHITECTS.

2	8/09/12	ADDENDUM NO.2: NEW SHEET		
REVISION:	DATE:	DESCRIPTION:	MADE BY:	APPROVED:
COUNTY OF HAWAI'I DEPT. OF PUBLIC WORKS — BUILDING DIVISION				

CORPORATION COUNSEL / LIQUOR CONTROL OFFICE
HAZARDOUS MATERIAL MITIGATION AND IMPROVEMENTS
UNDER MY OBSERVATION.
DETAILED IN CHAPTER 16-115 OF
WISTRATIVE RULES, DEPT. OF

UNDER MY OBSERVATION.

JOB NO. B-4087A

JOB NO. B-4087A HILO LAGOON CENTER 101 Aupuni Street, Unit 230 & Suite 325 T.M.K.: 2-2-014: 010 HILO, HAWAI'I

AV SYSTEM - DETAILS

D. L. ADAMS ASSOCIATES, LTD.

970 N. KALAHEO AVE, A-311

KAILUA, HAWAII 96734

808/254-3318 FAX 808/254-5295

BUILD


REVIEWED BY:


BUILDING DIVISION CHIEF DATE
DEPT. OF PUBLIC WORKS
COUNTY OF HAWAII

DATE: AUG '12
SHEET NO:
AV 4.4
SHT OF SHTS

DESIGNED BY: TRB

DRAWN BY: APD CHECKED BY: GLM

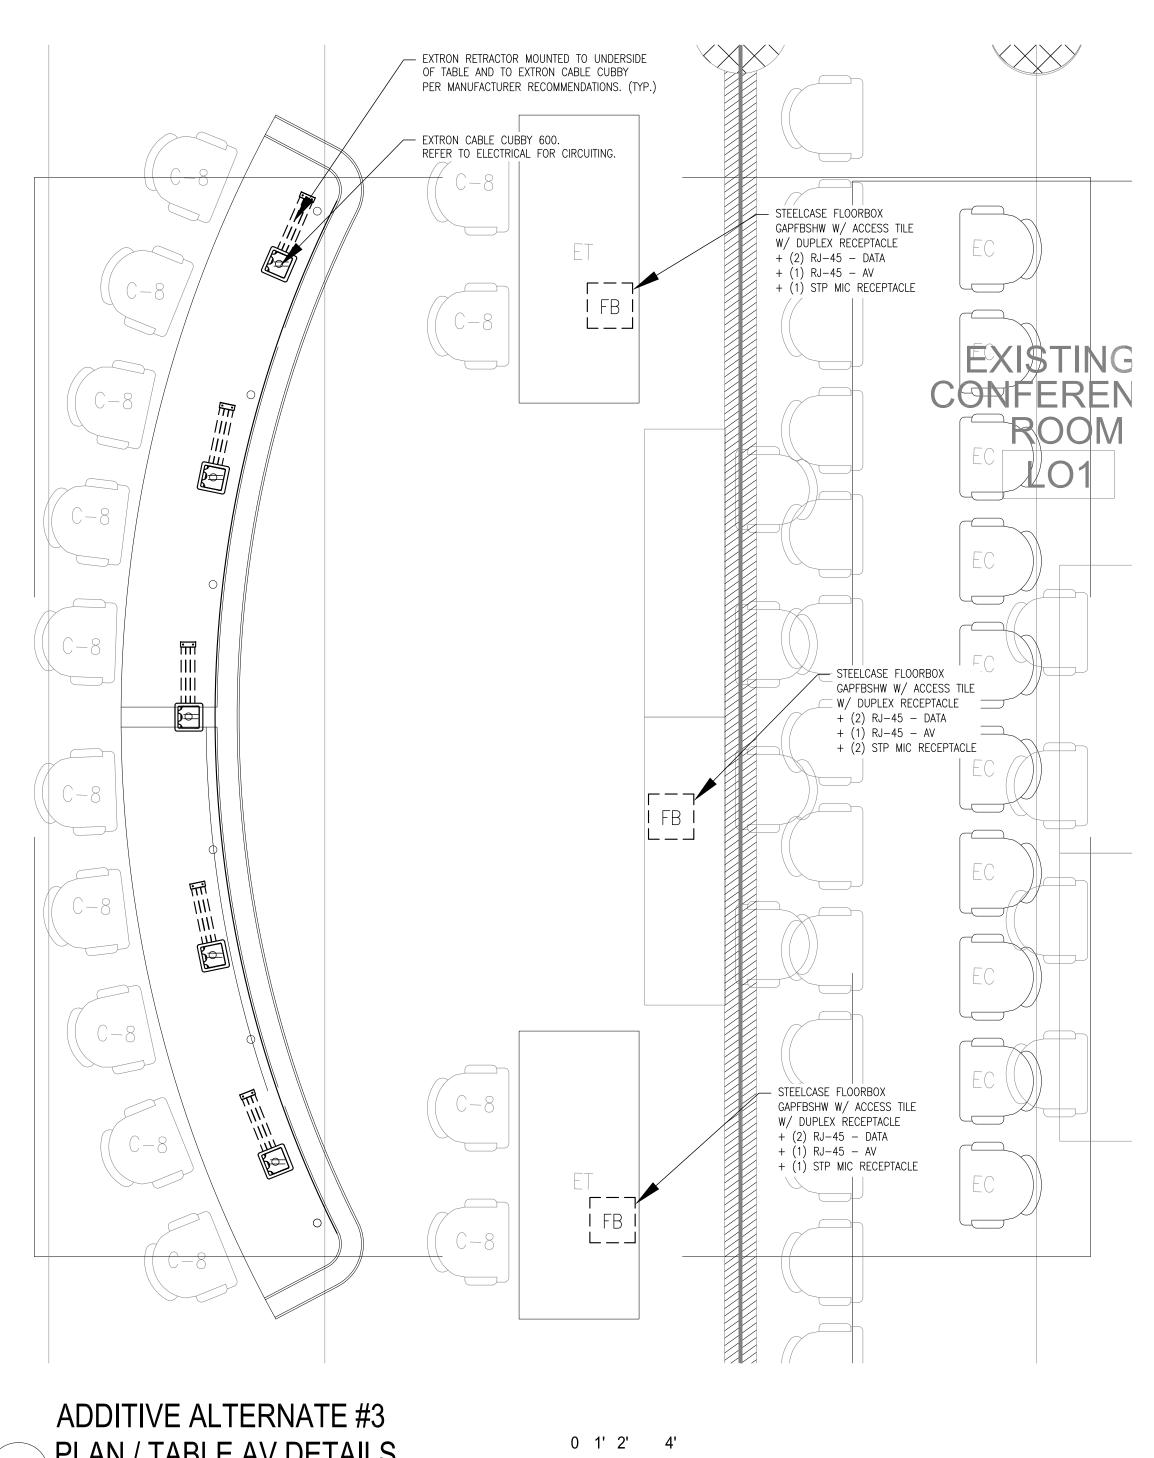

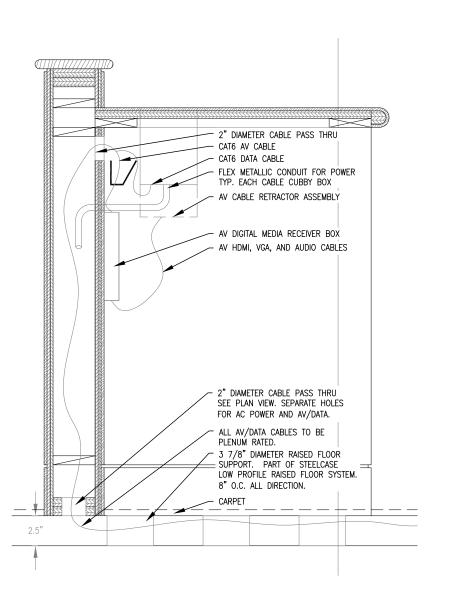


ADDITIVE ALTERNATE #3 SECTION AT CONFERENCE TABLE AV DETAIL 0 2' 4' 8' **2** SCALE: 1-1/2" = 1'-0"



PLAN / TABLE AV DETAILS

SCALE: 1/2" = 1'-0"



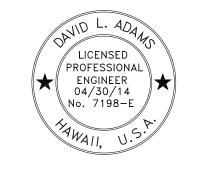


THIS WORK WAS PREPARED BY ME OR UNDER MY SUPERVISION AND CONSTRUCTION OF THIS PROJECT WILL BE UNDER MY OBSERVATION. OBSERVATION AS DETAILED IN CHAPTER 16-115 OF THE HAWAII ADMINISTRATIVE RULES, DEPT. OF COMMERCE AND CONSUMER AFFAIRS, ENTITLED PROFESSIONAL ENGINEERS, ARCHITECTS, SURVEYORS, AND LANDSCAPED ARCHITECTS.

8/09/12 ADDENDUM NO.2: NEW SHEET DESCRIPTION: MADE BY: APPROVED: REVISION: DATE:

COUNTY OF HAWAI'I DEPT. OF PUBLIC WORKS - BUILDING DIVISION

CORPORATION COUNSEL / LIQUOR CONTROL OFFICE HAZARDOUS MATERIAL MITIGATION AND IMPROVEMENTS PHASE II, RESTORATION JOB NO. B-4087A HILO LAGOON CENTER 101 Aupuni Street, Unit 230 & Suite 325 T.M.K.: 2-2-014: 010 HILO, HAWAI'I

EXISTING LIQUOR CONTROL DEPARTMENT/RESTORATION

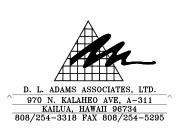

CABINET AV DETAILS **DESIGNED BY:** TRB

DATE

REVIEWED BY:

BUILDING DIVISION CHIEF DEPT. OF PUBLIC WORKS COUNTY OF HAWAII

DRAWN BY: APD CHECKED BY: GLM DATE: AUG '12 SHEET NO: **AV 4.5** SHT OF SHTS